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Revisions

No. Description 0 PERMIT SET 1 BID SET

01/11/21 02/03/21



BID SET

02/03/21

Project Number CC20034

Drawing Title

ELECTRICAL LEGEND, ABBREVIATIONS, &

GENERAL NOTES

•	COMPOSION	JOEON JO	
CONDUCTOR	208/120V, 240/120V	480/277V	ABOVE 600V
PHASE A	BLACK	BROWN	RED
PHASE B	RED	ORANGE	BLUE
PHASE C	BLUE	YELLOW	BLACK
NEUTRAL	WHITE	GRAY	-
GROUND	GREEN	GREEN	-
ISO GROUND	GN/YL	GN/ YL	-

A THIS IS A STANDARD LEGEND SHEET. SOME SYMBOLS OR ABBREVIATIONS MAY APPEAR ON THIS SHEET AND NOT ON THE PROJECT DRAWINGS. B CONDUIT RUNS MARKED WITH CROSSHATCHES INDICATE NUMBER OF #12 AWG

CONDUCTORS. CROSSHATCH WITH DOT INDICATES GROUND WIRE. SIZE CONDUIT ACCORDING TO SPECIFICATIONS AND APPLICABLE CODES UNLESS OTHERWISE NOTED.

GENERAL NOTES

DRAWING INDEX

ELECTRICAL LEGEND, ABBREVIATIONS, & GENERAL

ELECTRICAL ONE-LINE DIAGRAM AND GROUNDING

ELECTRICAL TAP OUT SYSTEM INTERCONNECTION

ELECTRICAL LIGHTING GROUND FLOOR PLAN - WEST

ELECTRICAL LOW VOLTAGE GROUND FLOOR PLAN -

ELECTRICAL POWER GROUND FLOOR PLAN

REV

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C TAG NUMBER DENOTES DEVICES ADDRESS.

DESCRIPTION

ELECTRICAL SITE PLAN

ELECTRICAL DETAILS

ELECTRICAL DETAILS

ELECTRICAL SCHEDULES

ELECTRICAL SITE LIGHTING PLAN

ELECTRICAL LIGHTING CONTROLS PLAN

ELECTRICAL ENLARGED PLAN

NOTES

D CONDUCTORS AND CONDUIT ARE SIZED ON BASIS OF COPPER, THHN-2/THWN-2. CIRCUITS THROUGH 100A SIZED ON BASIS OF 60°C. CIRCUITS GREATER THAN 100A SIZED ON BASIS OF 75°C, UNLESS NOTED OTHERWISE. CONDUIT SHALL BE EMT, UNLESS NOTED OTHERWISE.

MOUNT ALL EQUIPMENT PER SPECIFICATIONS UNLESS INDICATED OTHERWISE. REFER TO PLAN DRAWINGS AND SECTIONS FOR MOUNTING HEIGHTS.

F ALL ENCLOSURES ARE NEMA 1 UNLESS INDICATED OTHERWISE: 3R = NEMA 3R, X = EXPLOSION PROOF 4X = NEMA 4X, WP = WEATHER PROOF

G LUMINAIRE SYMBOLS SHOWN ARE GENERIC GRAPHIC REPRESENTATIONS. REFER TO LUMINAIRE SCHEDULE FOR SPECIFIC SOURCE, TYPE AND MOUNTING

H CONDUIT AND WIREWAY ROUTING IS SCHEMATIC. FIELD ROUTE.

ELECTRICAL CONTRACTOR SHALL PROVIDE (FURNISH AND INSTALL) ALL ELECTRICAL COMPONENTS. SUPPORT AND TERMINATIONS UNLESS NOTED OTHERWISE.

K ELECTRICAL CONTRACTOR SHALL MAINTAIN UPDATED PANEL SCHEDULES DURING PROJECT AND PROVIDE FINAL TYPE WRITTEN SCHEDULES AT END OF PROJECT TO ENGINEER AND PLACE COPY IN POWER PANEL

CONTRACTOR SHALL WALK PROJECT AREA PRIOR TO BID. TIME AND MATERIALS REQUIRED DUE TO DIFFICULTY OF ROUTING AND IMPACTS TO BUILDING CONSTRUCTION THAT ARE VISIBLE AT TIME OF WALK SHALL BE INCLUDED IN FINAL BID SUBMISSION. AREAS THAT CAN NOT BE VIEWED AT TIME OF BID SHALL BE SPECIFICALLY NOTED AND

EXCLUDED IN BID FOR CONSTRUCTION IN AWARD PROCESS. M COORDINATE EQUIPMENT/ DEVICE LOCATIONS WITH ARCHITECTURAL DRAWINGS.

N ALL BREAKERS INSTALLED SHALL BE RATED PER A.I.C RATING OF SYSTEM. P ALL INTERCONNECTION CABLES WILL BE PROVIDED BY VENDOR, EXCEPT AS NOTED.

CONTRACTOR TO VERIFY INSTALLATION REQUIREMENTS. Q CONTRACTOR SHALL VERIFY ALL EQUIPMENT SUPPLIED FROM FACILITY POWER SERVICE

IS FED VIA A LOCKABLE BREAKER OR SWITCH, SIZED PER N.E.C. PROVIDE AS REQUIRED.

R CONTRACTOR SHALL PROVIDE GROUNDING PER N.E.C. AND MANUFACTURER'S REQUIREMENTS. REFER TO TOOL MANUAL AND VERIFY WITH EQUIPMENT SUPPLIER.

S CIRCUIT RACEWAYS MAY BE COMBINED. ADJUST CONDUCTOR SIZE AS NEEDED FOR

TRANSITION TO LIQUID-TITE FLEXIBLE CONDUIT AT TERMINATION TO EQUIPMENT TO MINIMIZE VIBRATION TRANSMISSION.

CONTROLS SCOPE IS DESIGN-BUILD BY THE CONTROLS CONTRACTOR. DESIGN AND INSTALLATION SHALL BE IN ACCORDANCE WITH DRAWINGS, SPECIFICATIONS AND

SYMBOL DESCRIPTION

SECURITY AND MISCELLANEOUS TAP OUT SYSTEM SPEAKER IN CEILING TAP OUT SYSTEM SPEAKER, WALL MOUNTED CCTV P,T,Z SECURITY CAMERA (PAN, TILT, ZOOM) SECURITY DEVICE:

GB GLASS BREAK MONITOR CB CALL BUTTON

CR CARD READER DS DOOR STATUS SWITCH

ES ELECTRIC DOOR STRIKE KP KEY PAD

LA LOCAL DOOR ALARM LILO LOG IN/LOG OUT

CONDUCTOR COLOR CODES

CONDUCTOR	208/120V, 240/120V	480/277V	ABOVE 600V
PHASE A	BLACK	BROWN	RED
PHASE B	RED	ORANGE	BLUE
PHASE C	BLUE	YELLOW	BLACK
NEUTRAL	WHITE	GRAY	-
GROUND	GREEN	GREEN	-
ISO GROUND	GN/YL	GN/ YL	-

KEYED NOTES

- 1 FOR CONDUCTOR AND CONDUIT SIZES REFER TO DRAWING E6.01.
- TO PANEL HP CIRCUIT 21.
- 6 PROVIDE POWER TO FIRE SIGNAL AS SHOWN. CONNECT FIRE SIGNAL CIRCUIT TO PANEL HP CIRCUIT 25.
- 8 PROVIDE 1" CONDUIT FOR OPTICOM EMITTER CONTROLS CABLING. CABLING TO ACTIVATE SIGNAGE, COORDINATE WITH OWNER FOR MORE
- LOCATION WITH OWNER.

A SEE SHEET E0.01 FOR LEGEND, ABBREVIATIONS, & GENERAL NOTES.

- 2 PROVIDE POWER TO CAR CHARGING OUTLETS AS SHOWN. CONNECT CHARGER CIRCUITS TO PANEL HP CIRCUIT 32,34 & 36,38.
- 3 PROVIDE POWER TO FLAGPOLE AS SHOWN. CONNECT FLAGPOLE CIRCUIT
- 4 PROVIDE POWER TO LIFE JACKET BOARD AS SHOWN. CONNECT LIFE JACKET BOARD CIRCUIT TO PANEL HP CIRCUIT 23.
- 5 PROVIDE (3) 1" CONDUITS AND TERMINATE INTO EXISTING CENTURYLINK, ALYRICA, LS NETWORKS AND XFINITY PEDESTALS. COORDINATE ALL WORK WITH CENTURYLINK, LS NETWORKS AND XFINITY.
- 7 REFER TO 1/E4.01 FOR MORE INFORMATION.

Key Plan

A/

9 PROVIDE WEATHERPROOF RECEPTACLE IN YARD, COORDINATE FINAL

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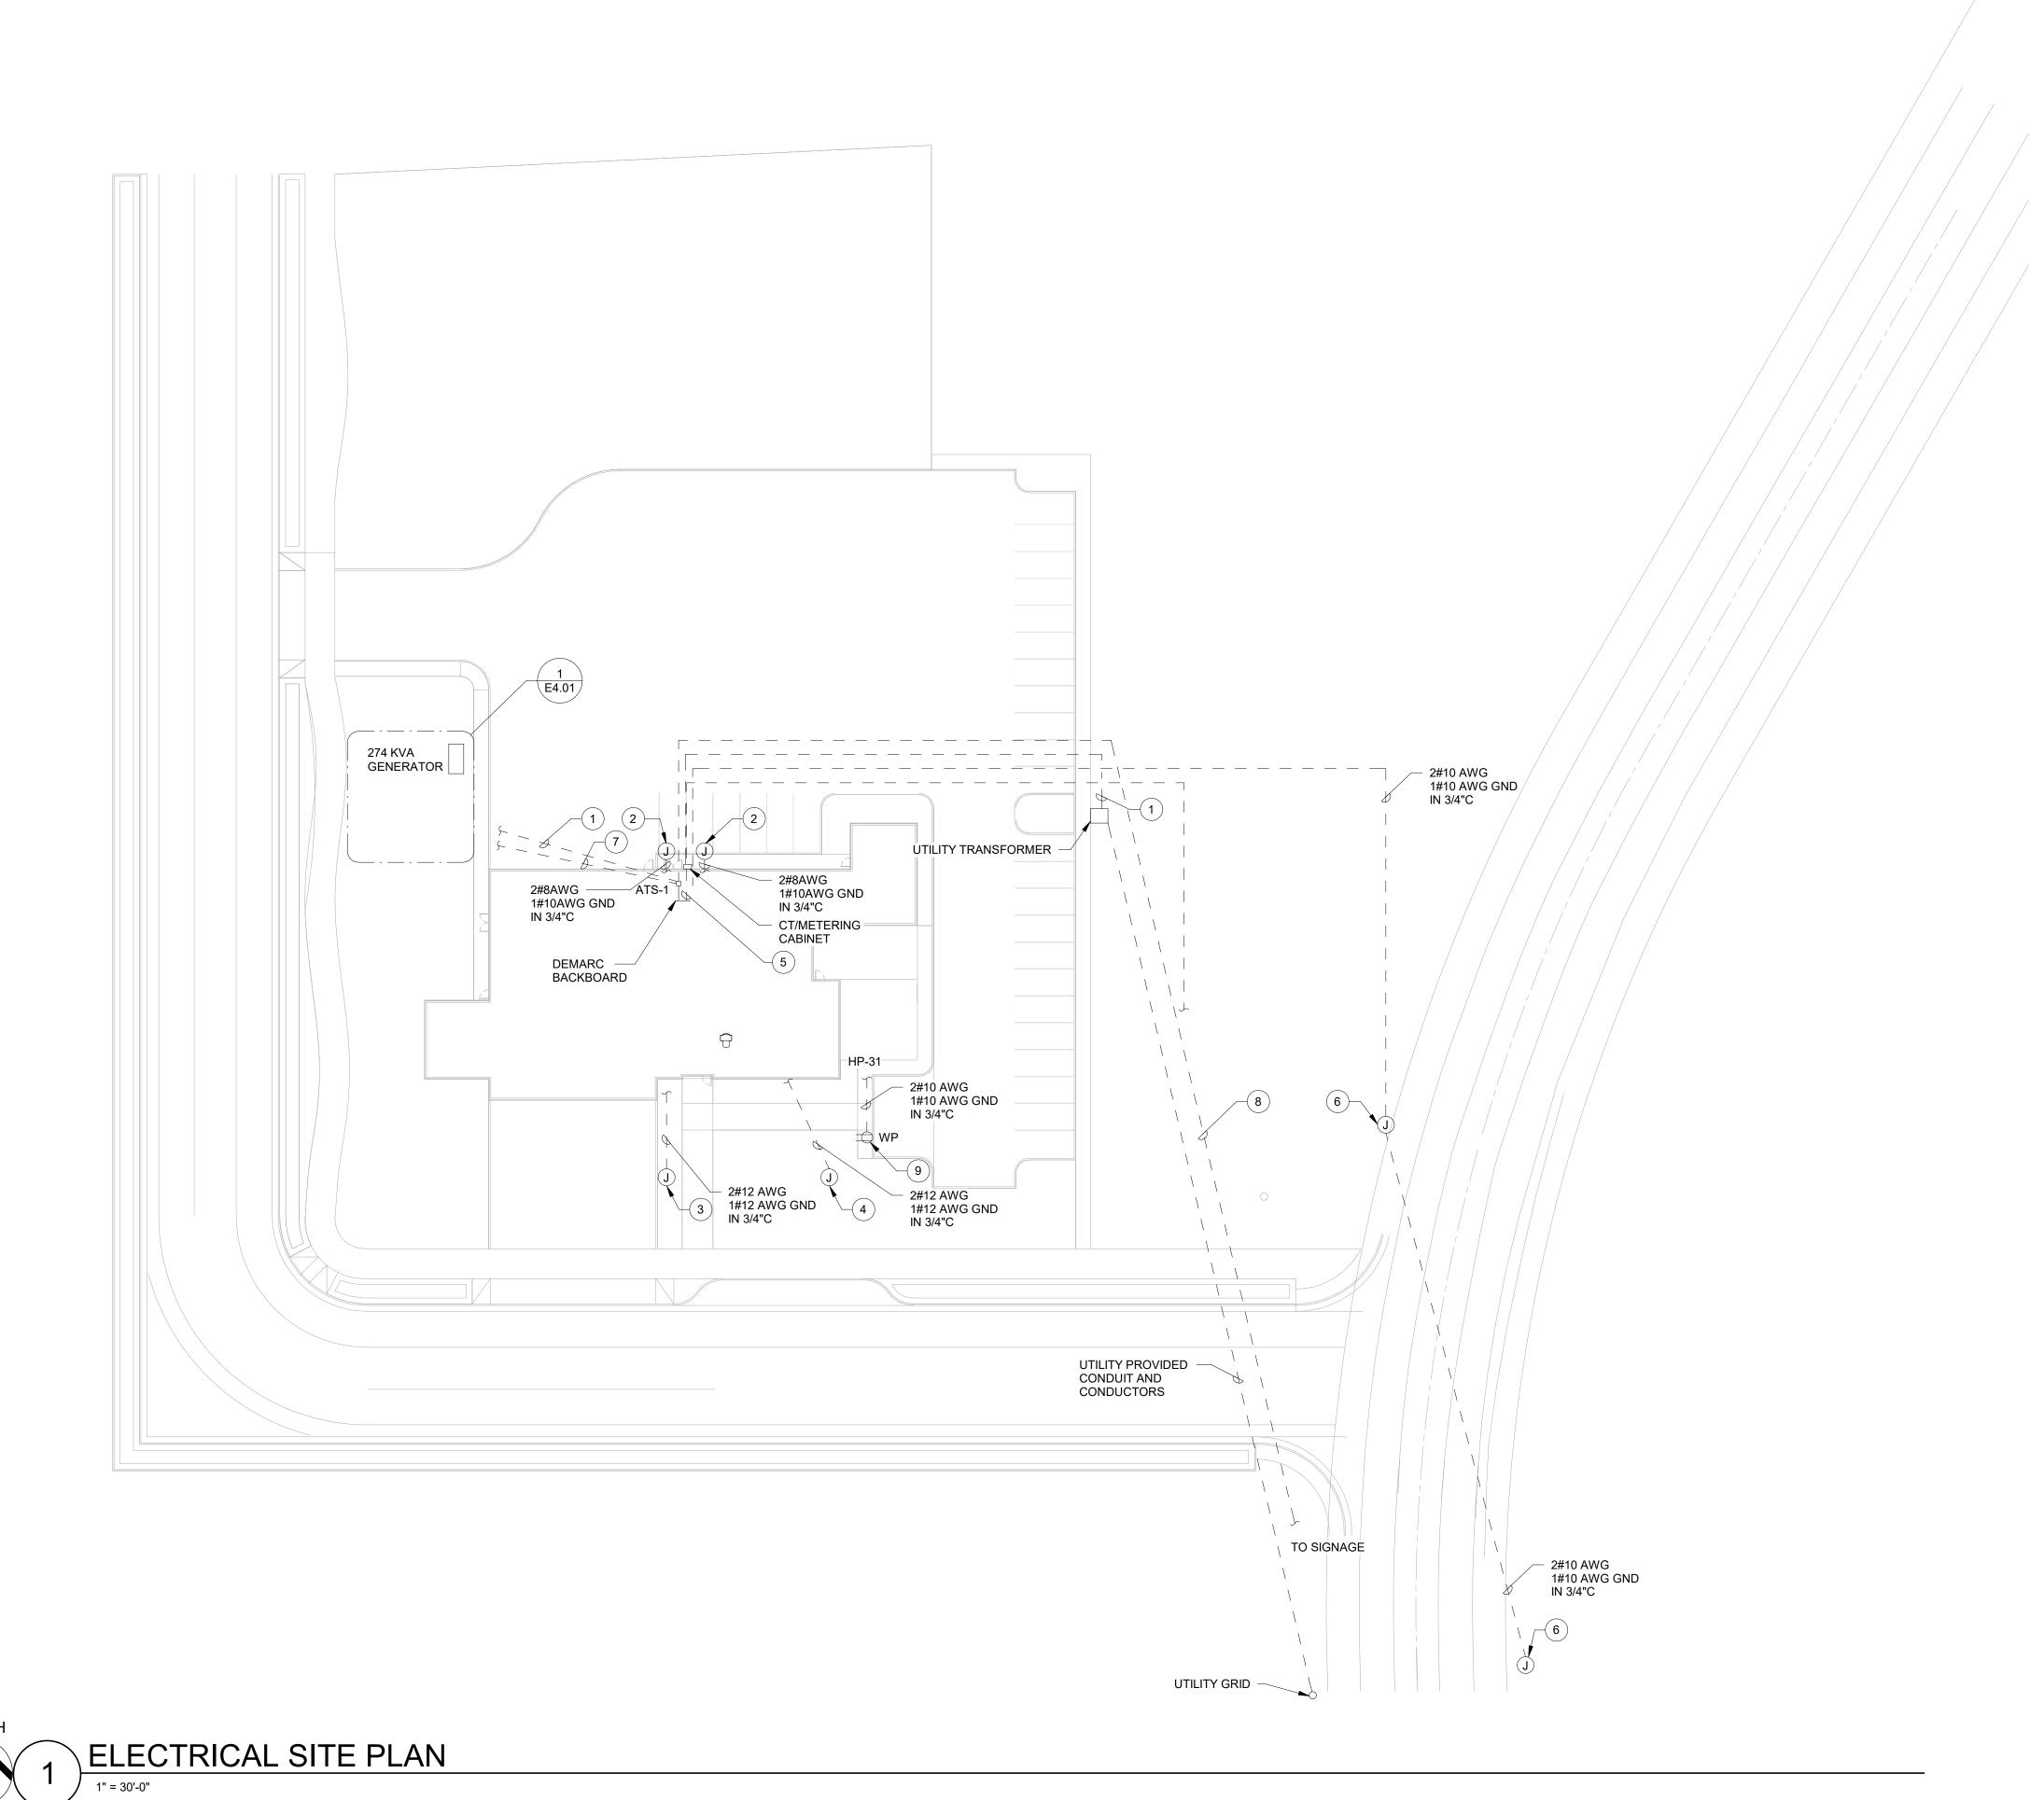
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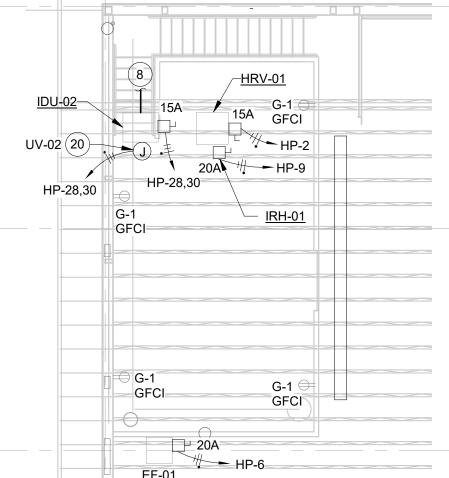
/B/

Drawing Title **ELECTRICAL SITE PLAN**

Sheet No E1.01



- 1 PROVIDE CONDUIT AND CONDUCTORS OF SIZE SHOWN ON E6.01 TO
- OPEN/CLOSE CONTROL AND SAFETY REVERSING SENSORS. REFER TO ARCHITECTURAL SPECIFICATION 08 36 13 FOR MORE INFORMATION. APPARATUS DOOR OPENING TO BE MANUALLY TRIGGERED DURING TAP OUT SYSTEM ALERT. COORDINATE WITH OWNER FOR PUSH BUTTON LOCATIONS. EACH DOOR TO BE ON DIFFERENT REMOTE GARAGE DOOR
- PROVIDE COMBINATION POWER/DATA FLOOR BOX UNDER CONFERENCE
- PROVIDE 3/4" CONDUIT IN SLAB FROM FLOOR BOX TO DIGITAL WHITE
- CONTROLS CABLING. REFER TO MANUFACTURERS DRAWINGS FOR MORE
- 9 PROVIDE WALL SWITCH FOR EXHAUST FAN AND CONNECT TO LOCAL
- 10 PROVIDE 3/4" CONDUIT FROM BRANCH SELECTOR BOX BC-01 TO EACH IDU FOR CONTROLS CABLING. REFER TO MANUFACTURERS DRAWINGS FOR
- 11 PROVIDE WALL SWITCH AND INTERCONNECTING CONDUCTORS FOR SINK
- 12 PROVIDE NEMA L6-15 RECEPTACLE FOR WASHING MACHINE AT LOCATION
- 13 PROVIDE WALL SWITCH AND INTERCONNECTING CONDUCTORS FOR
- COMPRESSOR AT LOCATION SHOWN. COORDINATE FINAL COMPRESSOR
- 15 PROVIDE RECEPTACLE FOR DAYROOM TELEVISION, COORDINATE FINAL
- BUILDING FOR CHRISTMAS LIGHTS. CONFIRM FINAL LOCATIONS AND



ELECTRICAL ROOM AS SHOWN. PROVIDE POWER AND CONTROLS WIRING

FROM PANEL TO GENERATOR PER MANUFACTURER'S REQUIREMENTS.

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EXPIRES: 12/31/2022

BID SET

02/03/21

Project Number CC20034

Drawing Title

ELECTRICAL POWER GROUND FLOOR PLAN

E1.02

ELECTRICAL ENLARGED PLAN

GENERAL NOTES

- A SEE SHEET E0.01 FOR LEGEND, ABBREVIATIONS, & GENERAL NOTES.

KEYED NOTES

- ATTENUATED EXTERIOR ENCLOSURE AT LOCATION SHOWN. REFER TO E6.01 FOR MORE INFORMATION. PROVIDE HOUSEKEEPING PAD FOR GENERATOR.
- NEMA 3R ENCLOSURE AT LOCATION SHOWN. REFER TO E6.01 FOR MORE INFORMATION. PROVIDE HOUSEKEEPING PAD FOR TRANSFER SWITCH.
- 3 PROVIDE 800A RATED TEMPORARY GENERATOR TERMINATION CABINET IN NEMA 3R ENCLOSURE AT LOCATION SHOWN. REFER TO E6.01 FOR MORE
- 4 PROVIDE 6" THICK CONCRETE PAD, MINIMUM 3" LARGER THAN UNITS ALL
- 5 PROVIDE 2#10 AWG AND 1#10 AWG GROUND FOR CONNECTION TO GENERATOR BLOCK HEATER. CONNECT CIRCUIT TO HVAC PANEL CIRCUIT
- 6 PROVIDE 2#4 AWG AND 1#10 AWG GROUND FOR CONNECTION TO GENERATOR BATTERY CHARGER. CONNECT CIRCUIT TO HVAC PANEL

- B FOR CONDUCTOR SIZES REFER TO ONE-LINE DIAGRAM ON DRAWING E6.01.

- 1 PROVIDE 274KVA DIESEL GENERATOR IN WEATHER PROOF, SOUND
- 2 PROVIDE 800A, 4-POLE, 208 VOLT RATED MANUAL TRANSFER SWITCH IN
- INFORMATION. PROVIDE HOUSEKEEPING PAD FOR CABINET.
- AROUND, #4 AT 12" ON CENTER, EACH WAY. SEE STRUCTURAL NOTES.

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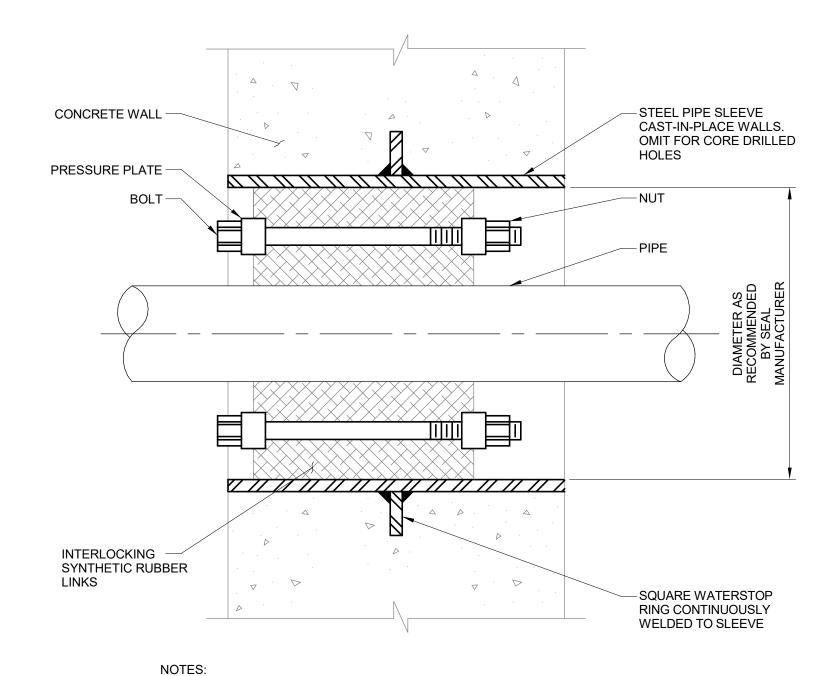
Project Number CC20034

Drawing Title

ELECTRICAL ENLARGED PLAN


E4.01

CONCRETE ENCASED ELECTRODE DETAIL




A FOR SUB GRADE PENETRATIONS DEEPER THAN 5' BELOW ADJACENT FINISH GRADE.

EXTERIOR WALL PENETRATION DETAIL

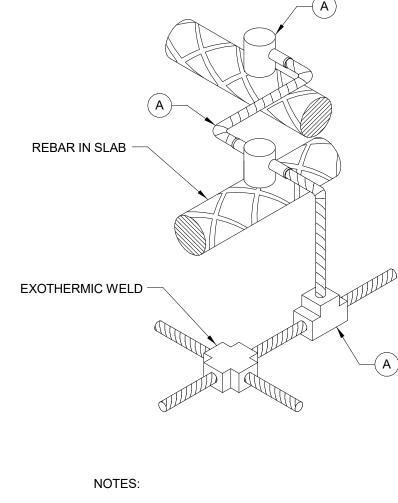


INSTALL GROUND CONDUCTOR 3" MIN FROM REBAR AND CONNECT TO REBAR.

GROUND CONDUCTOR BOND TO REBAR DETAIL

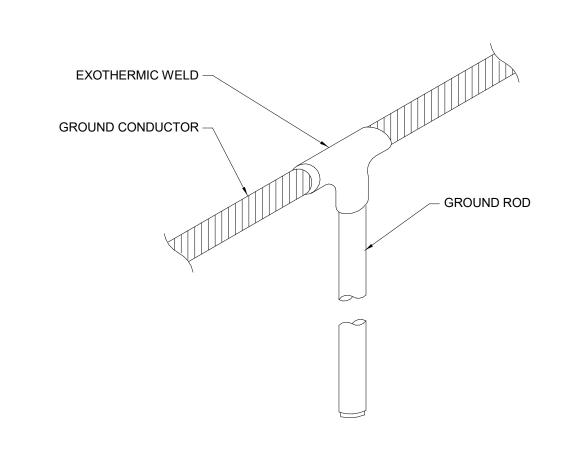


GROUND ROD INSTALLATION DETAIL

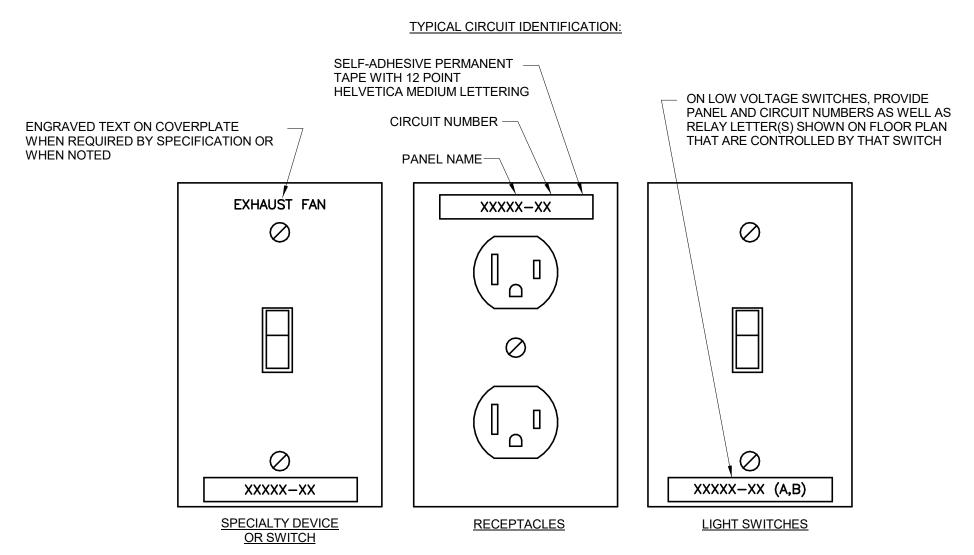


NOTES:

- REFER TO SPECIFICATIONS FOR ADDITIONAL INFORMATION AND COLORS OF TAPE REQUIRED FOR
- TEXT SHOWN ABOVE IS FOR EXAMPLE ONLY. MODIFY TEXT AS REQUIRED TO MATCH INSTALLATION.
- SIMILARLY LABEL DEVICES IN SURFACE METAL RACEWAYS, POWER POLES, FLOOR BOXES, CONCEALED MULTI-SERVICE POWER BOXES, ETC.
- PROVIDE ONLY ONE LABEL FOR MIDDLE SWITCH WHERE MULTIPLE SWITCHES ARE GROUPED UNDER COMMON COVERPLATE AND ARE SERVED FROM SAME CIRCUIT. PROVIDE MULTIPLE LABELS IF DIFFERENT CIRCUITS ARE USED.

DEVICE AND SWITCH LABELING DETAIL NOT TO SCALE

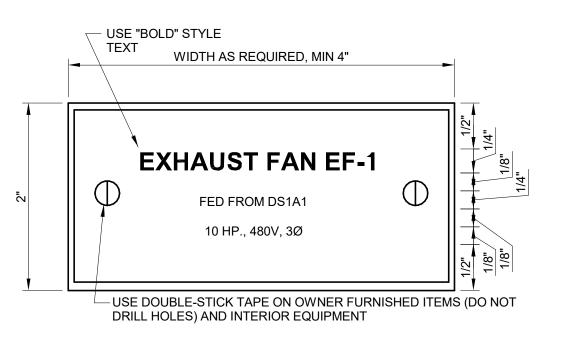

GENERAL EQUIPMENT

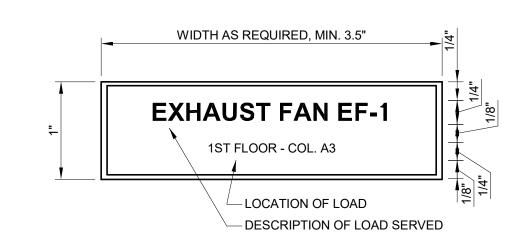

CIRCUIT BREAKERS IN DIST. PANELS NOTES:

- A SEE DRAWINGS FOR ADDITIONAL NAMEPLATE INFORMATION AND COLORS OF NAMEPLATES FOR DIFFERENT SYSTEMS.
- TEXT SHOWN ABOVE IS FOR EXAMPLE ONLY. MODIFY TEXT AS REQUIRED TO MATCH EQUIPMENT SPECIFICATIONS.
- C CENTER ALL TEXT HORIZONTALLY.

EQUIPMENT IDENTIFICATION NAMEPLATES DETAIL NOT TO SCALE

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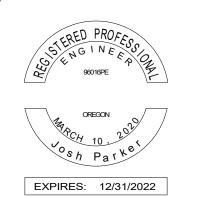
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Revisions No. Description

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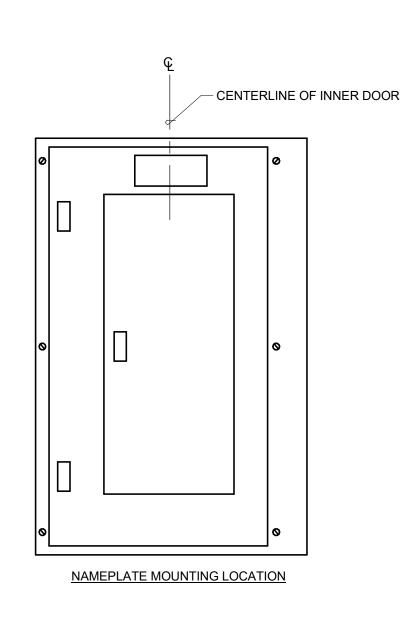
Project Number

CC20034

Drawing Title

ELECTRICAL DETAILS


E5.01




NOTES:

- A SEE DRAWINGS FOR ADDITIONAL NAMEPLATE INFORMATION AND COLORS OF NAMEPLATES FOR DIFFERENT
- B PROVIDE ONE NAMEPLATE FOR EACH PANEL OR MCC SECTION. WHERE SECTION NUMBER TWO AND ABOVE ARE WITHIN SAME ROOM AND WITHIN 10' OF EACH OTHER USE THE SMALLER SIZE NAMEPLATE.
- C CENTER ALL TEXT HORIZONTALLY.
- D TEXT SHOWN ABOVE IS FOR EXAMPLE ONLY. MODIFY TEXT AS REQUIRED TO MATCH EQUIPMENT

DISTRIBUTION PANEL MOTOR CONTROL CENTER AND BRANCH PANEL NAMEPLATES DETAIL NOT TO SCALE

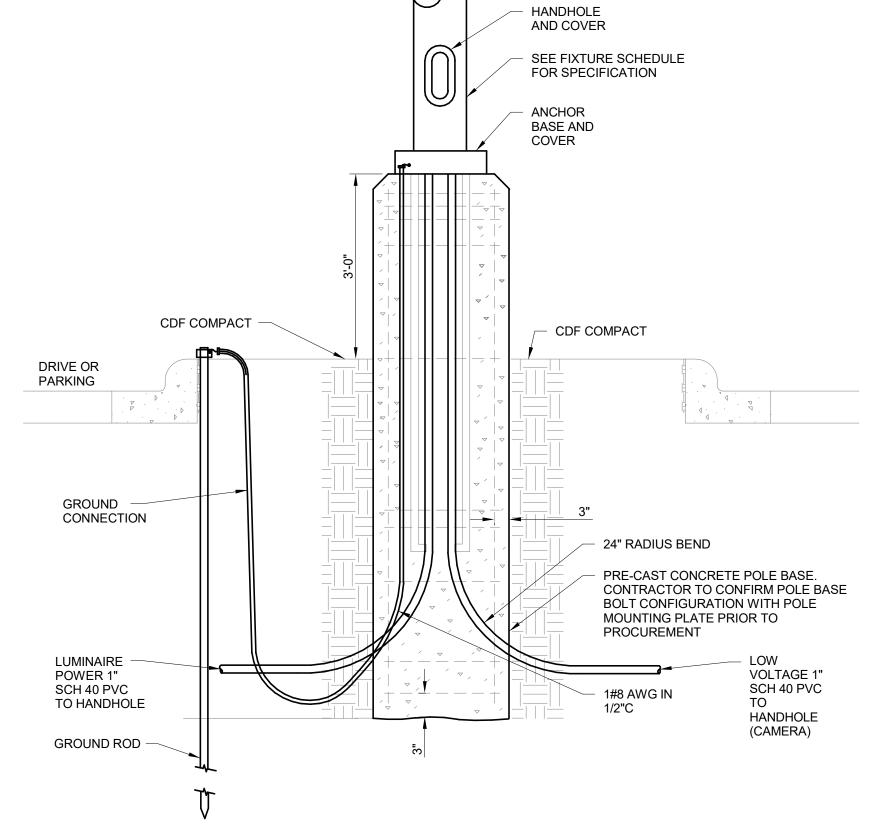


ROUND POLE BASE DETAIL - ONSITE LIGHTING NOT TO SCALE

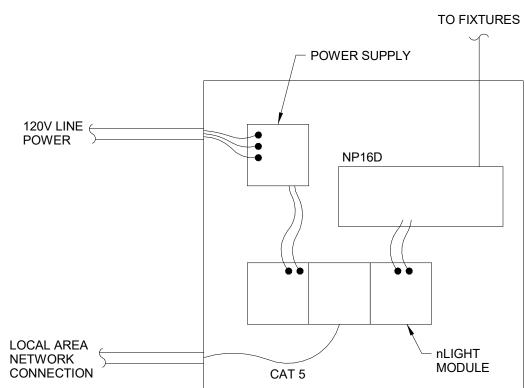

A NLIGHT CONTROL PANEL LAYOUT IS PRELIMINARY, COORDINATE WITH LIGHTING VENDOR.

NLIGHT LIGHTING CONTROL PANEL

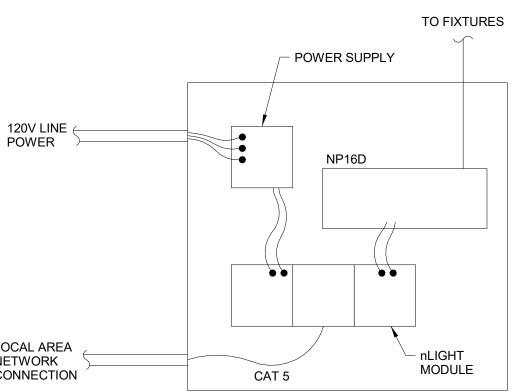

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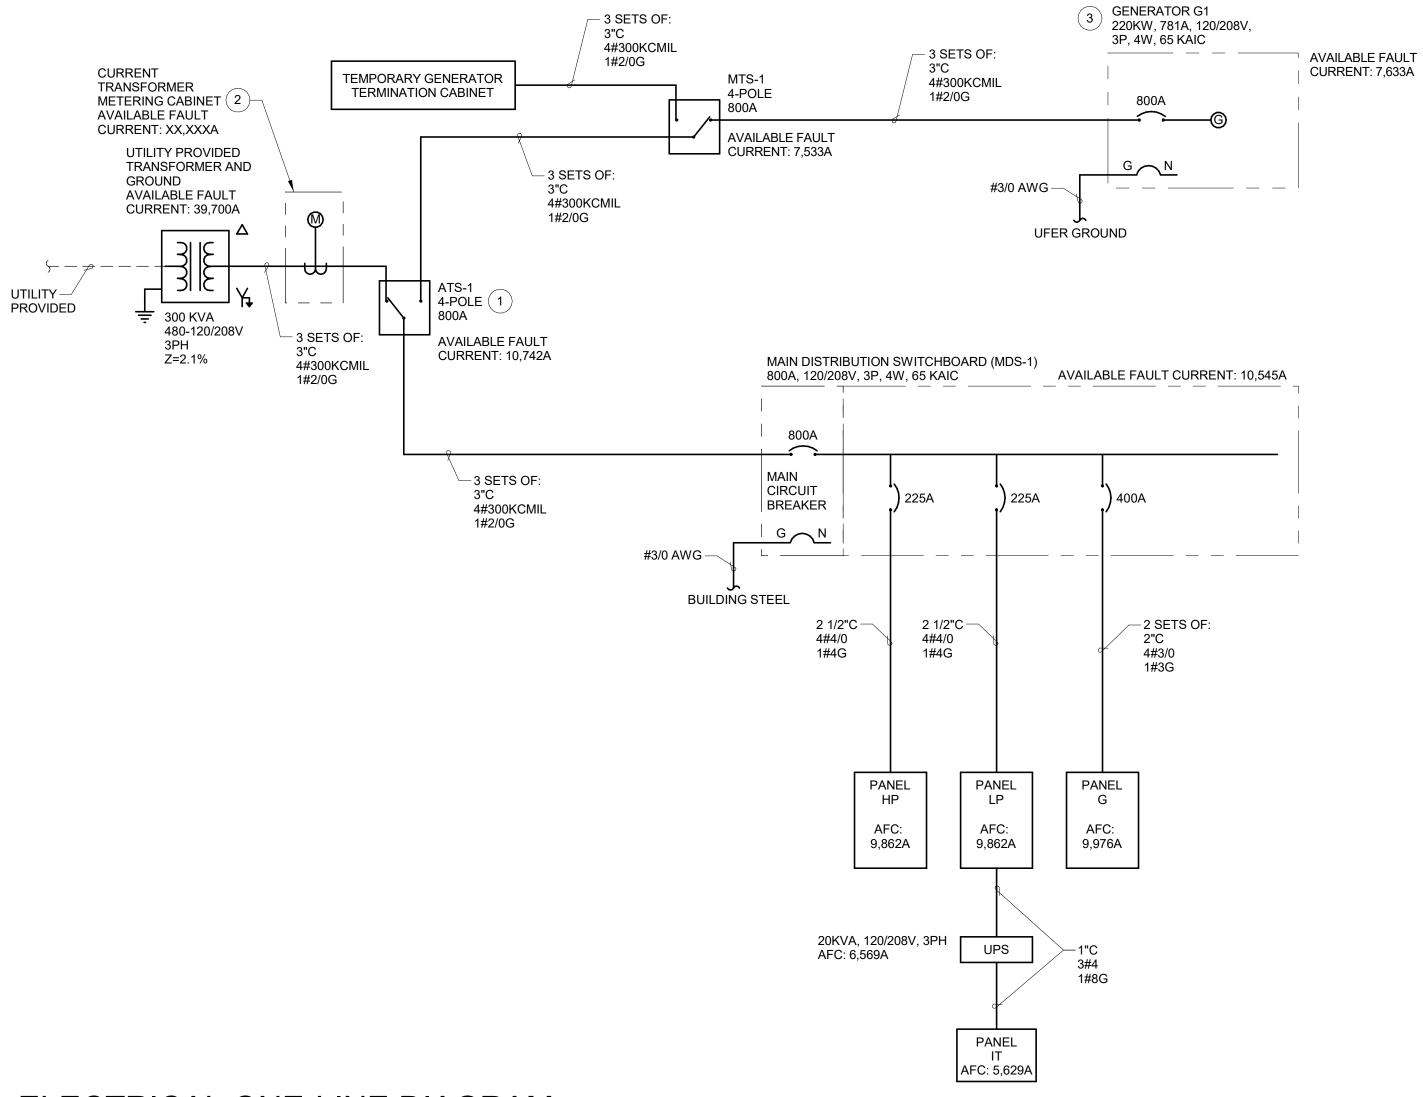
Project Number CC20034

Drawing Title


ELECTRICAL DETAILS

E5.02

LOAD SUMMARY - MDS-1 800A, 208/120V, 3Ø											
Load:	kVA	Amps									
PANEL HVAC (HP)	59.11	164.07									
LIGHTING PANEL (LP)	28.48	79.06									
GENERAL PANEL (G)	63.57	176.45									
TOTAL MDS-1 LOADING	151.16	419.58									



ELECTRICAL ONE-LINE DIAGRAM

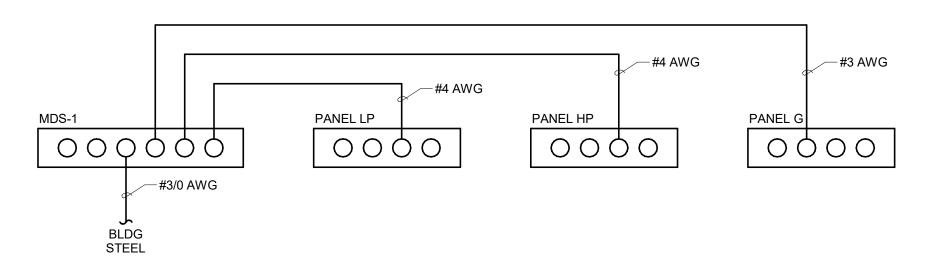

ELECTRICAL GROUNDING DIAGRAM

GENERAL NOTES

- A SEE SHEET E0.01 FOR LEGEND, ABBREVIATIONS, & GENERAL NOTES.
- B SEE SHEET E5.01 FOR GROUNDING DETAILS.

KEYED NOTES

- 1 PROVIDE 800 AMP, 4-POLE, 208 VOLT RATED AUTOMATIC TRANSFER SWITCH IN NEMA 1 ENCLOSURE. TRANSFER SWITCH TO BE SERVICE
- 2 PROVIDE CURRENT TRANSFORMER METERING CABINET PER PACIFIC POWER SPECIFICATIONS. PACIFIC POWER TO INSTALL CURRENT TRASNFORMER METERS IN CABINET. CONTACT TUCKER HILL 541-967-6161 FOR MORE INFORMATION.
- 3 PROVIDE 220KW, 3PH, 120/208V KOHLER DIESEL GENERATOR WITH 1200 GALLON BELLY FUEL TANK IN NEMA 3R ENCLOSURE MODEL NUMBER 230REOZJE WITH ALTERNATOR 4UA9. GENERATOR TO BE CAPABLE OF RUNNING AT FULL LOAD FOR 72 HOURS. GENERATOR TO BE MOUNTED ON CONCRETE PAD AT LOCATION SHOWN ON E4.01.

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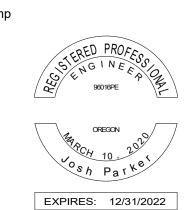


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Drawing Title

ELECTRICAL ONE-LINE DIAGRAM AND GROUNDING DIAGRAMS

E6.01

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'			
!			

MISCELLANEOUS

TOTAL LOAD (KVA):

TOTAL AMPS:

188.00

TOTAL LOAD:

TOTAL AMPS:

		FIXTURE SCHEDULE ABEL DESCRIPTION LAMP LAMP LUMENS WATTS VOLTAGE CATALOG NUMBER MANUFACTURER MOUNTING NOTES													
ABEL	DESCRIPTION	LAMP	LAMP LUMEN	IS WATTS	VOLTAGE	CATALOG NUMBER	MANUFACTURER	MOUNTING	NOTES						
Α	RECESSED 2'X4' LED TROFFER FIXTURE. 4000K COLOR TEMPERATURE, 80CRI, 120V.	LED 4000K	3,638	29	120V	2BLT4-40LHE-ADSM-EZ1-LP840	LITHONIA OR APPROVED	RECESSED							
В	4' STRIP LED FIXTURE. 4000K COLOR TEMPERATURE, 80CRI, 120V.	LED 4000K	2,712	25	120V	ZL1N-L48-3000LM-FST-120-40K-80CRI-WH	LITHONIA OR APPROVED	SURFACE/CHAIN							
С	HIGH BAY LED FIXTURE. 4' LENGTH, CLEAR ACRYLIC LENS, 4000K COLOR TEMPERATURE, 80CRI, 120V	LED 4000K	16,567	115	120V	IBG-18000LM-SEF-ACL-WD-120-GZ10-40K-80CRI- HLN360ADC-DNA	LITHONIA OR APPROVED	CHAIN	INDIVIDUAL OCCUPANCY SENSOR CONTROLS. E FIXTUF TO BE ALWAYS ON						
D	RECESSED LED DOWNLIGHT FIXTURE. 4000K COLOR TEMPERATURE, 80CRI, 120V.	LED 4000K	2,009	23	120V	LDN6-40/20-LO6AR-LSS-120-GZ10	LITHONIA OR APPROVED	RECESSED	IP55 RATED (NOTE 2)						
E	RECESSED 2'X2' LED TROFFER FIXTURE. 4000K COLOR TEMPERATURE, 80CRI, 120V.	LED 4000K	2,967	26	26 120V 2BLT2-33L-ADSM-EZ1-LP940 LITHONIA OR AP		LITHONIA OR APPROVED	RECESSED	IP55 RATED						
F	RECESSED LED DOWNLIGHT FIXTURE. 4000K COLOR TEMPERATURE, 80CRI, 120V.	LED 4000K	759	8.9	120V	LDN6-40/07-LO6AR-LSS-120-GZ10	LITHONIA OR APPROVED	RECESSED							
G	RECESSED 8' STRIP LED FIXTURE. 4000K COLOR TEMPERATURE, 80CRI, 120V.	LED 4000K	5,610	48.2	120V	TZL1N-L96-6000LM-FST-120-40K-90CRI-WH	LITHONIA OR APPROVED	SURFACE							
Н	POLE MOUNTED LED FIXTURE. T4M DISTRIBUTION TYPE, 4000K COLOR TEMPERATURE, 120V. COLOR SHALL BE BLACK. NOTE 1	LED 4000K	26,697	241	120V	DSX1-LED-P9-40K-T4M-120-SPA-PIRH1FC3V-DBLXD	LITHONIA OR APPROVED	30' POLE (SEE BELOW FOR SPEC)	ROUND POLE MOUNTING. FUI CUT OFF. INTEGRAL MOTION/AMBIENT SENSOR.						
I	WALL PACK LED FIXTURE. WIDE DISTRIBUTION TYPE, 4000K COLOR TEMPERATURE, 80CRI, 120V. COLOR SHALL BE BLACK	LED 4000K	4,526	35	120V	WDGE2-LED-P4-40K-80CRI-VW-120-SRM-PIR1FC3V	LITHONIA OR APPROVED	WALL	MOUNT AT 15'. INTEGRAL MOTION/AMBIENT SENSOR. (NOTE 2)						
J	POLE MOUNTED LED FIXTURE. T3 DISTRIBUTION TYPE, 4000K COLOR TEMPERATURE, 120V. COLOR SHALL BE BLACK.	LED 4000K	28,000	295	120V	125-25S-R3-DG	AMERICAN ELECTRIC LIGHTING	30' POLE (SEE BELOW FOR SPEC)	ROUND POLE MOUNTING. FU CUT OFF. INTEGRAL MOTION/AMBIENT SENSOR.						
L	WARNING LIGHT, STROBE TUBE, 120V, RED COLOR, POLYCARBONATE LENS.	STROBE TUBE	N/A	9.6	120V	2ERP4	GRAINGER OR APPROVED	WALL	FIXTURE TO BE ACTIVATED E TAPOUT SYSTEM EMERGENC COMMAND						
М	BOLLARD LED FIXTURE, 4000K COLOR TEMPERATURE, IP65 RATED, VANDAL RESISTANT, DOME TOP, 120V.	LED 4000K	995	41	120V	UCO-10117-41W-1-W40-02-120/277V-OCC1	LIGMAN OR APPROVED	BOLLARD	INTEGRAL MOTION SENSOR						
0	OUTDOOR LED BULLET FLOOD LIGHT WITH FLOOD DISTRIBUTION AND 5000K LENS, 120V.	LED 5000K	839	11	120V	OLBF-8-50K-DDB	LITHONIA OR APPROVED	GROUND	MOTION SENSOR/ADAYLIGHT CONTF 145 DEGREE AIMING ANGLE FOR SIGNAGE. AIM TOWARDS FLAG FO FLAG POLE						
Х	LED EXIT FIXTURE. THERMOPLASTIC HOUSING, RED COLOR, BATTERY BACKUP, 120-277V	LED	N/A	1	120V	LQM SW R 120/277 EL N	LITHONIA OR APPROVED	SURFACE							
POLE	ROUND STRAIGHT STEEL POLE. GALVANIZED FINISH, 30' HEIGHT, SINGLE LUMINAIRE MOUNT, 3"X5" HANDHOLE WITH COVER.	N/A	N/A	N/A	N/A	RSS30B4-4-GC-D190-FA	НАРСО	N/A							

PANEL:	PANEL G	SC RMS:	35	kAIC	AVAILA	BLE FAULT:	9.98	KA VOLTAGE:	208Y/120V	
	FEEDER: SEE ONE LINE	MAIN RATING:	400	A MLO	LOCATIO	N: ELEC. RO	ОМ	POWER TYPE:	EMERGENCY	
CKT		CKT BREAKER		LOAD		LOAD		CKT BREAKER		CKT
NO.	CIRCUIT DESCRIPTION	POLES/AMPS	Туре	Volt-Amps	PHASE	Volt-Amps	Туре	POLES/AMPS	CIRCUIT DESCRIPTION	NO.
1	MEZZANINE RECEPTACLES	20-1	R	720	Α	645	Е	15-2	WASHING MACHINE	2
3	RM 131 RECEPTACLES	20-1	R	720	В	645	Е	-	-	4
5	RM 131 BIKE/ROWER	20-1	Е	1000	С	1800	Е	20-1	KITCHEN MICROWAVE	6
7	RM 131 STAIRMASTER	20-1	Е	1000	Α	1800	Е	20-1	KITCHEN REFRIGERATOR	8
9	RM 131 TREADMILL	20-1	E	1000	В	1800	Е	20-1	KITCHEN MICROWAVE	10
11	RM 130 RECEPTACLES	20-1	R	540	С	1200	E	20-1	DISHWASHER	12
13	RM 132/129/125 RECEPTACLES/EF-02	20-1	R	960	A	1200	E	20-1	KITCHEN RECEPTACLES	14
15	RM 128 RECEPTACLES	20-1	R	540	В	1260	R	20-1	RM LOCKERS 110, 115-117 RECEPT	16
17	RM 128/125 RECEPTACLE	20-1	R	360	С	1080	R	20-1	RM 118-120/122 RECEPTACLES	18
19	RM 101/134 RECEPTACLES	20-1	R	900	A	1320	R	20-1	STORAGE/HALLWAY/125 RECEPT./EF-03	20
21	RM 103-105 RECEPTACLES	20-1	R	720	В	1080	R	20-1	RM 121 RECEPACLES	22
23 25	RM 105/LAUNDRY/HALL RECEPTACLES RM 109/HALLWAY RECEPTACLES	20-1 20-1	R	1080 900	C	360 540	R R	20-1 20-1	RM 121 PROJECTOR/FLOOR OUTDOOR RECEPTACLES	24 26
27	RR/HALLWAY RECEPTACLES	20-1	R R	720	A B	1080	R	20-1	HALLWAY/DINING RECEPTACLES	28
29	KITCHEN COUNTER RECEPTACLES	20-1	R	720	С	1080	R	20-1		30
31	ESPRESSO MACHINE	15-1	E	1200	A	900	R	20-1	DAYROOM/HALLWAY RECEPTACLES RM 133 RECEPTACLES	32
33	APP BAY RECEPTACLES	20-1	R	180	В	540	R	20-1	APP BAY RECEPTACLES	34
35	STORAGE 127	20-1	R	180	С	1500	E	20-1	BATTERY CHARGING/STORAGE	36
37	APP BAY RECEPTACLES	20-1	R	180	A	1500	E	20-1	BATTERY CHARGING/STORAGE	38
39	APP BAY RECEPTACLES	20-1	R	180	В	1500	E	20-1	BATTERY CHARGING/STORAGE	40
41	APP BAY GARAGE DOOR	20-1	М	528	C	1500	E	20-1	BATTERY CHARGING/STORAGE	42
43	APP BAY GARAGE DOOR	20-1	М	528	A	1500	E	15-1	KITCHEN STOVE/HOOD	44
45	APP BAY GARAGE DOOR	20-1	М	528	В	1800	E	20-1	KITCHEN REFRIGERATOR	46
47	APP BAY GARAGE DOOR	20-1	М	528	C	1800	E	20-1	KITCHEN REFRIGERATOR	48
49	APP BAY GARAGE DOOR	20-1	М	528	Α	400	Е	20-1	KITCHEN DISPOSAL	50
51	QT-54 AIR COMPRESSOR	40-2	М	1737	В	645	Е	15-2	WASHING MACHINE	52
53	-	-	М	1737	С	645	Е	-	-	54
55	RM 128 ICE MACHINE	20-1	Е	1056	Α	1500	Е	20-1	DAYROOM CEILING FANS	56
57	UNDER COUNTER REFRIGERATOR	20-1	Е	1000	В	900	R	20-1	RM 121 RECEPT	58
59	OUTDOOR RECEPTACLES	20-1	R	1080	С	500	Е	20-1	SPRINKLER CONTROL PANEL	60
61	APP BAY VEHICLE POWER DROP	20-1	R	1300	Α	4160	Е	50-2	FUTURE ELECTRIC KITCHEN OVEN	62
63	APP BAY VEHICLE POWER DROP	20-1	R	1300	В	4160		-	-	64
65	APP BAY VEHICLE POWER DROP	20-1	R	1300	С			20-0	SPARE	66
67	APP BAY VEHICLE POWER DROP	20-1	R	1300	Α			20-1	SPARE	68
69	APP BAY VEHICLE POWER DROP	20-1	R	1300	В			20-1	SPARE	70
71	SPARE	20-1			С			20-1	SPARE	72
73	SPARE	20-1			A			20-1	SPARE	74
75	SPARE	20-1			В			20-1	SPARE	76
77	SPARE	20-1			C			20-1	SPARE	78
79	SPARE	20-1			A			20-1	SPARE	80
81	SPARE	20-1			В			20-1	SPARE	82
83	SPARE CONNECTED LOAD (VA)	20-1		CALCULATE	C D L OAD (F	I PER NEC 220)	<u> </u>	20-1	SPARE PANEL LOAD	84
		07 200 00			•					
	RECEPTACLES:	27,320.00	IU KVA	A + 50% OF RE	WAINDEK	18,660.0	JU		208Y/120V	
	LIGHTING:	0.00		125%		0.00	20	-		
	EQUIPMENT/MOTORS: LARGEST EQUIP MOTOR:	34,296.00	1050	100% % OF LARGES	T EOLUP	34,296.0 0.00	JU	-		
	HEATING:	0.00	123	% OF LARGES 100%	ו בעטור	0.00		PHASE A:	26,037.00	
	COOLING/MOTORS:	6,114.00		100%		6,114.0	0	PHASE B:	25,335.00	
	LARGEST MOTOR:	0.00	125%	6 OF LARGEST	MOTOR	0.00	•	PHASE C:	20,518.00	
-	MISCELLANEOUS	0.00	·	100%		0.00		1	_0,0.0.00	

163.96

TOTAL AMPS:

71.89

199.55

PANEL:	PANEL IT	SC RMS:	35	kAIC	AVAILA	BLE FAULT:		KA VOLTAGE:	208Y/120V	
	FEEDER: SEE ONE LINE	MAIN RATING:	70	A MCB	LOCATIO	N: IT ROOM		POWER TYPE:	UPS	
CKT		CKT BREAKER		LOAD		LOAD		CKT BREAKER		CK
10.	CIRCUIT DESCRIPTION	POLES/AMPS			PHASE	Volt-Amps	Type	POLES/AMPS	CIRCUIT DESCRIPTION	NC
			7.		İ					
1	IT ROOM RECEPTACLE	20-1	R	180	Α	500	Е	20-1	ALERT CONTROL PANEL	2
3	IT ROOM RECEPTACLE	20-1	R	180	В	500	Е	20-1	DSP	4
5	RTU TAPOUT SYSTEM	20-1	Е	500	С	500	Е	20-1	RADIO	6
7	AMPLIFIER	20-1	Е	500	Α	500	Е	20-1	GENERATOR ANNUNCIATOR PANEL	8
9	AMPLIFIER	20-1	Е	500	В			20-1	SPARE	10
11	SPARE	20-1			С			20-1	SPARE	12
13	SPARE	20-1			Α			20-1	SPARE	14
15	SPARE	20-1			В			20-1	SPARE	16
17	SPARE	20-1			С			20-1	SPARE	18
19	SPARE	20-1			Α			20-1	SPARE	20
21	SPARE	20-1			В			20-1	SPARE	22
23	SPARE	20-1			С			20-1	SPARE	24
	CONNECTED LOAD (VA)			CALCULATE	D LOAD (F	PER NEC 220)			PANEL LOAD	
	RECEPTACLES:	360.00	10 KVA + 50% OF REMAINDER 360.00)		208Y/120V	
	LIGHTING:	0.00		125%		0.00				
	EQUIPMENT/MOTORS:	3,500.00	100%			3,500.00				
	LARGEST EQUIP MOTOR:	0.00	125	% OF LARGES	T EQUIP	0.00				
	HEATING:	0.00		100%		0.00		PHASE A:	1,680.00	
	COOLING/MOTORS:	0.00		100%		0.00		PHASE B:	1,180.00	
	LARGEST MOTOR:	0.00	125%	6 OF LARGES	Γ MOTOR	0.00		PHASE C:	1,000.00	-
	MISCELLANEOUS	0.00		100%		0.00			,,,,,,,,,,,,,,,,,,,,,,,,,,,,,,,,,,,,,,,	
	TOTAL LOAD (KVA):	3.86		TOTAL LOA	AD:	3.86		TOTAL LOAD:	3.86	
	TOTAL AMPS:	10.71		TOTAL AMI	PS:	10.71	1	TOTAL AMPS:	10.71	
IOTES:		•				<u> </u>				
1.)										
2.)										
3.)									1-Feb-21	

PANEL:	PANEL LP	SC RMS:	35	kAIC	AVAILA	BLE FAULT:	9.86	KA VOLTAGE:	208Y/120V	
	FEEDER: SEE ONE LINE	MAIN RATING:	225	A MLO	LOCATIO	N: ELEC. ROO	OM.	POWER TYPE:	EMERGENCY	
CKT NO.	CIRCUIT DESCRIPTION	CKT BREAKER POLES/AMPS		LOAD Volt-Amps	PHASE	LOAD Volt-Amps		CKT BREAKER POLES/AMPS	CIRCUIT DESCRIPTION	Ck
		1	- 7				- 7			T
1	RM 128-131 & MEZZ.	20-1	L	853	Α	964	L	20-1	EXTERIOR LIGHTING	2
3	APPARATUS BAY	20-1	L	1495	В			20-1	SPARE	4
5	RM 101-103, 105-109 & 134	20-1	L	793	С	1205	L	20-1	EXTERIOR LIGHTING	6
7	RM 110-114, 124, 133 & 126	20-1	L	730	Α	175	L	20-1	WALLPACK LIGHTING	8
9	RM 115-1232	20-1	L	664	В	175	L	20-1	WALLPACK LIGHTING	10
11	EXTERIOR BOLLARD/FLOOD LIGHTING	20-1	L	287	С	175	L	20-1	WALLPACK LIGHTING	12
13	SPARE	20-1			Α			20-1	SPARE	14
15	SPARE	20-1			В			20-1	SPARE	16
17	SPARE	20-1			С			20-1	SPARE	18
19	SPARE	20-1			Α			20-1	SPARE	20
21	SPARE	20-1			В			20-1	SPARE	22
23	SPARE	20-1			С			20-1	SPARE	24
25	SPARE	20-1			A			20-1	SPARE	26
27	SPARE	20-1			В			20-1	SPARE	28
29	SPARE	20-1			C			20-1	SPARE	30
31 33	SPARE SPARE	20-1 20-1			A B			20-1 20-1	SPARE SPARE	32 34
35	SPARE	20-1			С			20-1	SPARE	36
37	SPARE	20-1			A	6667	E	70-3	20KVA UPS	38
39	SPARE	20-1			В	6667	E	70-3	-	40
41	SPARE	20-1			С	6667	E		_	42
71	CONNECTED LOAD (VA)	20-1		CAI CIII ATE		PER NEC 220)			PANEL LOAD	42
	· · ·									
	RECEPTACLES:	0.00	10 KVA		EMAINDER 0.				208Y/120V	
	LIGHTING:	7,516.00		125%		9,395.0				
	EQUIPMENT/MOTORS:	20,001.00		100%		20,001.0	00			
	LARGEST EQUIP MOTOR:	0.00	125	% OF LARGES	TEQUIP	0.00				
	HEATING:	0.00		100%		0.00		PHASE A:	9,389.00	
	COOLING/MOTORS:	0.00		100%		0.00		PHASE B:	9,001.00	
	LARGEST MOTOR:	0.00	125%	6 OF LARGEST	MOTOR	0.00		PHASE C:	9,127.00	
	MISCELLANEOUS	0.00		100%		0.00				
	TOTAL LOAD (KVA):	27.52		TOTAL LOA	۸D:	29.40)	TOTAL LOAD:	27.52	
	TOTAL AMPS:	76.38		TOTAL AMP	PS:	81.60)	TOTAL AMPS:	76.38	
NOTES:		•				•				
1.)										

PANEL:	PANEL HP	SC RMS:	35	kAIC	AVAILA	BLE FAULT:	9.55	KA VOLTAGE:	208Y/120V	
	FEEDER: SEE ONE LINE	MAIN RATING:	225	A MLO	LOCATIO	N: ELEC. RO	ОМ	POWER TYPE:	EMERGENCY	
CKT		CKT BREAKER		LOAD		LOAD		CKT BREAKER		CK
NO.	CIRCUIT DESCRIPTION	POLES/AMPS		Volt-Amps	PHASE	Volt-Amps		POLES/AMPS	CIRCUIT DESCRIPTION	NC
1	ODU-01A	50-3	E	3963	A	670	E	15-1	HRV-01	2
3	-	-	E	3963	В	1320	E	15-1	HRV-02	4
5 7	- IRH-05.06.07	20-1	E H	3963 930	C A	460 240	E E	20-1 20-1	EF-01 CP-01	6 8
9	IRH-05,06,07	20-1	Н	620	В	600	H	20-1	WH-01	10
11	IRH-02,03,04	20-1	Н	930	С	437	E	20-1	IDU-01,UV-01	12
13	RHP-03,04,05,06,07	20-2	H H	878	A	437	E	-	-	14
15	-		Н	878	В	234	E	20-2	IDU-03,04,05,09,13, RHP-08	16
17	RHP-01,02	20-2	Н	350	С	234	E	-	-	18
19	-	-	Н	350	A	198	Е	20-2	IDU-10,11,12,13,14,15	20
21	FLAGPOLE	20-1	Е	500	В	198	Е	-	-	22
23	LIFE JACKET BOARD	20-1	Е	500	С	1175	Е	20-2	IDU-06,07,08,UV-06,07,08	24
25	FIRE SIGNAL	20-1	Е	500	Α	1175	Е	-	-	26
27	GENERATOR BLOCK HEATER	20-1	Е	1500	В	218	Е	20-2	IDU-02,UV-02	28
29	GEN BATTERY CHARGER	60-1	Е	5000	С	218	E	-	-	30
31	YARD RECEPTACLE	20-1	Е	180	Α	3600	Е	40-2	CAR CHARGING OUTLET	32
33	ODU-01B	50-3	Е	3963	В	3600	Е	-	-	34
35	-	-	E	3963	С	3600	E	40-2	CAR CHARGING OUTLET	36
37	-	-	Е	3963	A	3600	E	-	-	38
39	SPARE	20-1			В			20-1	SPARE	40
41	SPARE	20-1			С			20-1	SPARE	42
	CONNECTED LOAD (VA)			CALCULATE	D LOAD (F	PER NEC 220))		PANEL LOAD	
	RECEPTACLES:	0.00	10 KV	A + 50% OF RE	MAINDER	0.00			208Y/120V	
	LIGHTING:	0.00		125%		0.00				
	EQUIPMENT/MOTORS:	53,572.00		100%		53,572.0	00	1		
	LARGEST EQUIP MOTOR:	0.00	125	% OF LARGES	TEQUIP	0.00				
	HEATING:	5,536.00		100%		5,536.0	0	PHASE A:	20,684.00	
	COOLING/MOTORS:	0.00		100%		0.00		PHASE B:	17,594.00	
	LARGEST MOTOR:	0.00	125%	% OF LARGEST	MOTOR	0.00		PHASE C:	20,830.00	
	MISCELLANEOUS	0.00		100%		0.00		ļ		
	TOTAL LOAD (KVA):	59.11		TOTAL LOA	ND:	59.11	1	TOTAL LOAD:	59.11	
	TOTAL AMPS:	164.07		TOTAL AME	PS:	164.0	7	TOTAL AMPS:	164.07	
NOTES:						-				
1.)										

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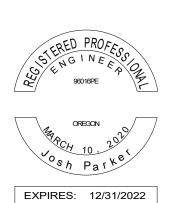


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Date 01/11/21 02/03/21

Revisions

No. Description0 PERMIT SET1 BID SET



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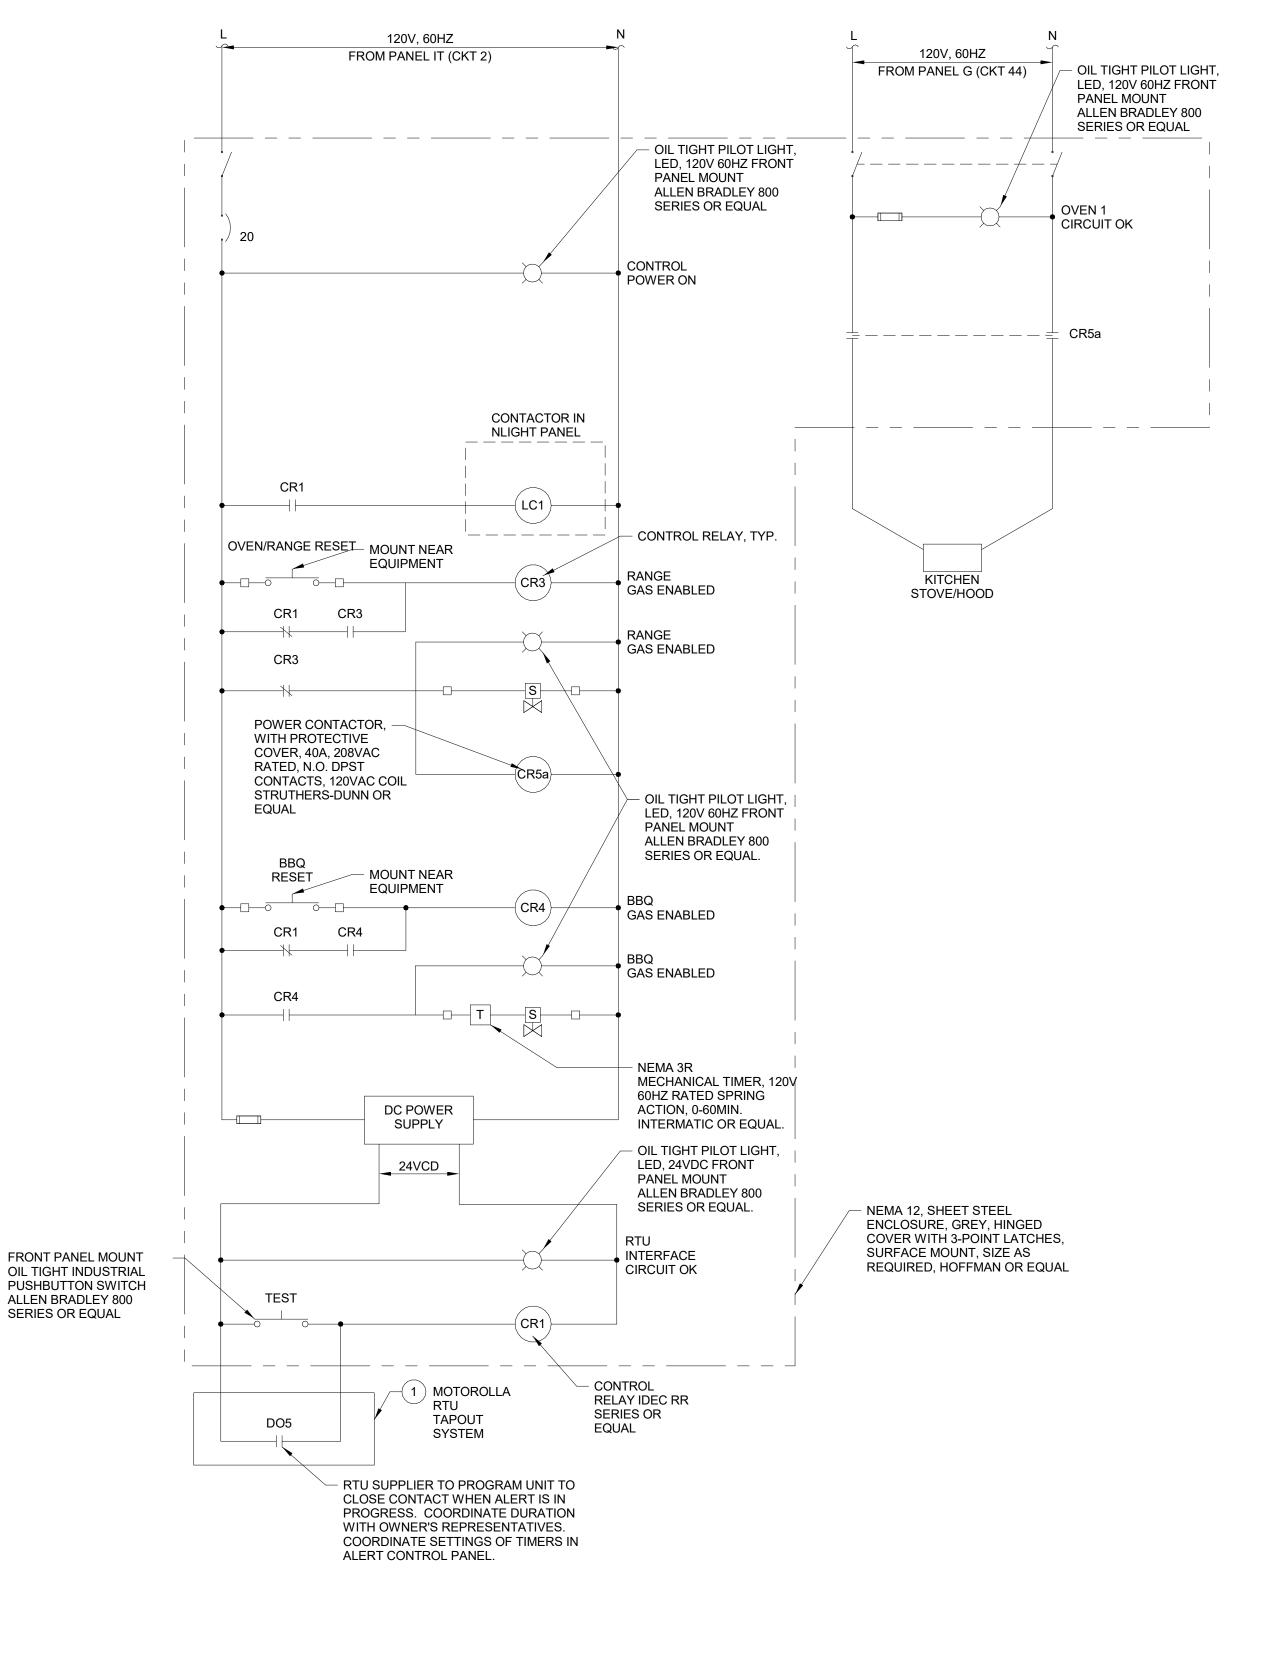
02/03/21

Project Number

CC20034

ELECTRICAL SCHEDULES

Sheet No **E6.02**




- A SEE SHEET E0.01 FOR LEGEND, ABBREVIATIONS, & GENERAL NOTES.
- B CONTRACTOR TO COORDINATE/PROVIDE ALL REQUIRED INTERCONNECTION FOR COMPLETE TAP OUT OPERATING SYSTEM. WHAT IS SHOWN IS BASED ON PRELIMINARY COORDINATION AND NOT ALL INTERCONNECTIONS SHOWN.
- C FOR COMPLETE LIST OF CUSTOMER TAP OUT FUNCTIONALITY REQUIREMENTS, REFERENCE TAP OUT MEMO APPENDIX B.

KEYED NOTES

- 1 COORDINATE WITH THE RTU SUPPLIER (OWNER FURNISHED SYSTEM). IDENTIFY DRY CONTACT IN THE RTU, CONFIRM CONTACT RATINGS AND PROVIDE COMPATIBLE SENSING CIRCUIT. COORDINATE CONTACT SENSE, TERMINAL IDENTIFICATIONS, FURNISH AND INSTALL ALL REQUIRED DEVICES TO PROVIDE THE FUNCTIONS SHOWN.
- 2 DEVELOP SHOP DRAWINGS FOR ACP, INCLUDING INTERNAL AND EXTERNAL ELEVATIONS, ELEMENTARY CONTROL DIAGRAMS, BILLS OF MATERIALS AND INTERCONNECTION SCHEMATIC. PROVIDE TERMINALS FOR ALL WIRES ENTERING/LEAVING THE ACP ENCLOSURE. PROVIDE PHENOLIC NAMEPLATES FOR THE FRONT OF THE PANEL AND BACK OF PANEL DEVICES.
- FOR NOTED INTERCONNECTION BETWEEN THE TAPOUT SYSTEM AND END DEVICES, ASSUME THE FOLLOWING: -SWITCHED BUTTONS, #14 AWG AS REQUIRED -RADIO 2#14 AWG -AMPLIFIER/DSP, 2#14 AWG, SHIELDED -SPEAKER LEDS, #14 AWG SEE DRAWINGS FOR DEVICE LOCATIONS/QUANTITIES

TAPOUT SYSTEM SEQUENCE OF OPERATIONS

- 1 PAGER SIGNAL, RADIO SIGNAL OR MANUAL DISPATCH SIGNAL TO INITIATE SYSTEM. TONES ARE GENERATED AND RECEIVED FROM DISPATCH. TONES GENERATED BY DISPATCH ARE AMBULANCE AND FIRST ALARM. UPON ACTIVATION ENERGIZE LIGHTS IN SLEEPING ROOMS, ENERGIZE LIGHTS IN HALLWAY, ENERGIZE LIGHTS IN APP BAY/SUPPORT SPACES, ENERGIZE AUDIBLE SIGNALING DEVICES, DE-ENERGIZE KITCHEN EQUIPMENT (GAS RANGE, ELECTRIC RANGE AND COUNTERTOP RECEPTACLES ONLY) AND DE-ENERGIZE BARBEQUE EQUIPMENT.
- 2 ANNUNCIATE TONE OVER SPEAKERS, THEN LOCKOUT TONE AND ANNUNCIATE RADIO DISPATCH OVER SAME SPEAKERS. ALL OTHER PAGING TO BE LOCKED OUT WHEN TAPOUT IS ENGAGED. COORDINATE INTERCONNECTION OF TAPOUT CONTROLLER AND PAGING EQUIPMENT SUPPLIER.
- 3 LIGHTS TO REMAIN ENERGIZED UNTIL SYSTEM IS MANUALLY RESET OR AUTOMATICALLY RESET. HALLWAY LIGHTING TO BE PROVIDED WITH OVERRIDE SWITCH TO PROVIDE A MEANS OF MANUAL SHUTOFF. AMBER DORM LIGHTS TO HAVE A GRADUAL INCREASE IN BRIGHTNESS UNTIL FULL BRIGHTNESS. OVERHEAD LIGHTS IN DORMS TO COME ON AFTER AMBER LEDS AT FULL OUTPUT.
- 4 ALL KITCHEN EQUIPMENT TO REMAIN DE-ENERGIZED UNTIL SYSTEM IS MANUALLY RESET. RESET SYSTEM VIA STATION/INTERNAL TIMER.

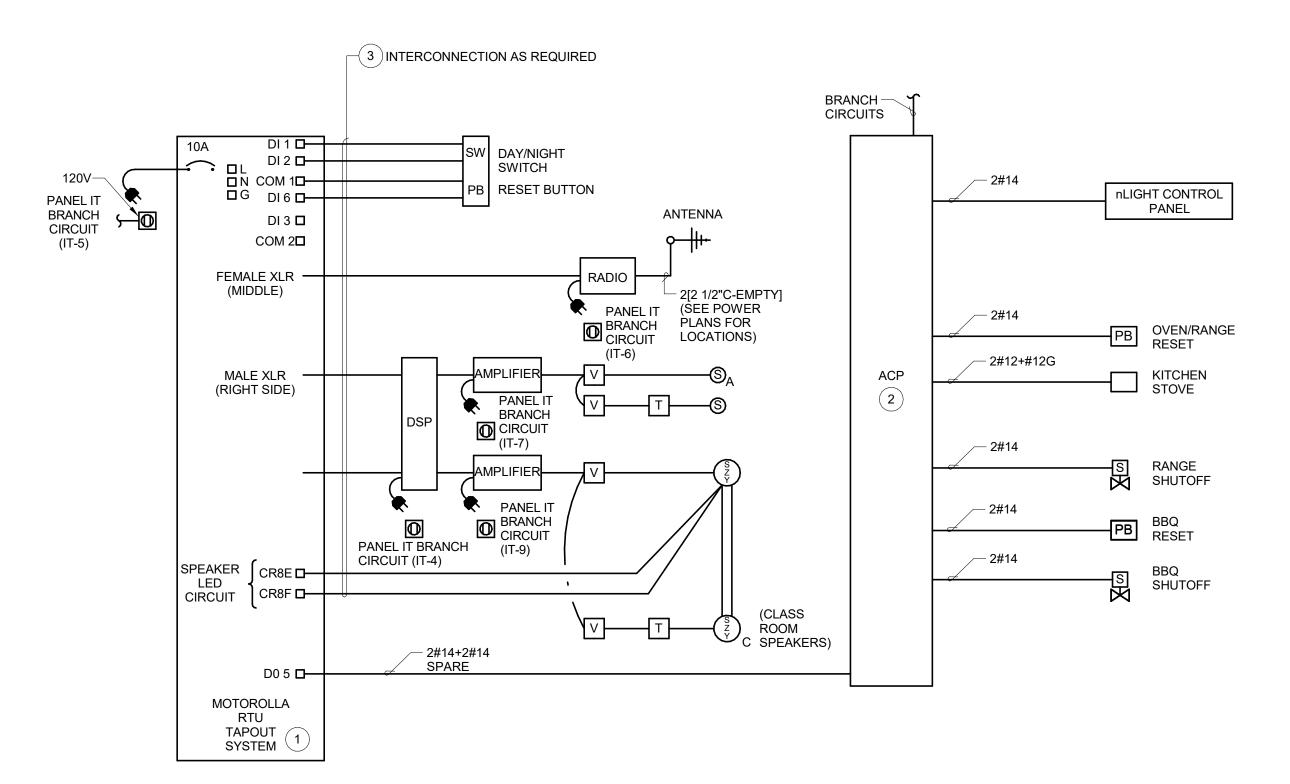

RTU INTERCONNECTION SCHEMATIC

NOT TO SCALE

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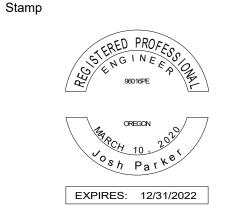


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02/03/21

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CC20034

Drawing Title

ELECTRICAL TAP OUT SYSTEM INTERCONNECTION DIAGRAM

E6.03

ALERT CONTROL PANEL (ACP) NOT TO SCALE

- A SEE SHEET E0.01 FOR LEGEND, ABBREVIATIONS, & GENERAL NOTES.
- B FOR LIGHTING FIXTURE SCHEDULE, REFER TO DRAWING E6.02.
- C ALL LIGHTING SHOWN IS ON SITE STANDBY GENERATOR.

KEYED NOTES

Key Plan

/A/

- 1 PROVIDE 30 FOOT ROUND LIGHTING POLE TO MOUNT FIXTURE ON. REFER TO DETAIL 2/E5.02 FOR MORE INFORMATION. OLD CASTLE PRECAST 7-LB OR EQUAL. COORDINATE FINAL POLE LOCATIONS WITH THE CITY OF MILLERSBURG.
- 2 CONNECT EXTERIOR SITE LIGHTING CIRCUIT TO LP CIRCUIT 2. PROVIDE (2) #10 AWG AND (1) #10 AWG GROUND CONDUCTOR IN 1" CONDUIT.
- 3 CONNECT EXTERIOR BOLLARD AND SIGNAGE LIGHTING CIRCUIT TO LP CIRCUIT #13. PROVIDE (2) #10 AWG AND (1) #10 AWG GROUND CONDUCTOR IN 1" CONDUIT.
- 4 CONNECT EXTERIOR SITE LIGHTING CIRCUIT TO LP CIRCUIT 6. PROVIDE (2) #10 AWG AND (1) #10 AWG GROUND CONDUCTOR IN 1" CONDUIT.
- 5 CONNECT EXTERIOR WALL PACK LIGHTING CIRCUIT TO LP CIRCUIT 8. PROVIDE (2) #10 AWG AND (1) #10 AWG GROUND CONDUCTOR IN 1" CONDUIT.
- 6 COORDINATE WITH PACIFIC POWER AND THE CITY OF MILLERSBURG FOR CONNECTION OF STREET LIGHTS. PROVIDE LIGHT POLE BASES PER PACIFIC POWER REQUIREMENTS.
- 7 CONNECT EXTERIOR WALL PACK LIGHTING CIRCUIT TO LP CIRCUIT #10. PROVIDE (2) #10 AWG AND (1) #10 AWG GROUND CONDUCTOR IN 1" CONDUIT.
- 8 CONNECT EXTERIOR WALL PACK LIGHTING CIRCUIT TO LP CIRCUIT #12. PROVIDE (2) #10 AWG AND (1) #10 AWG GROUND CONDUCTOR IN 1" CONDUIT.
- 9 PROVIDE 1" CONDUIT TO SOUTH SIDE OF NEW ROAD FOR FUTURE DEVELOPMENT.
- 10 MOUNT FIXTURES CENTERED OVER EACH APPARATUS BAY DOOR. PROVIDE ADDITIONAL LIGHT FIXTURE IF BAY 6 IS IN USE. COORDINATE WITH OWNER.

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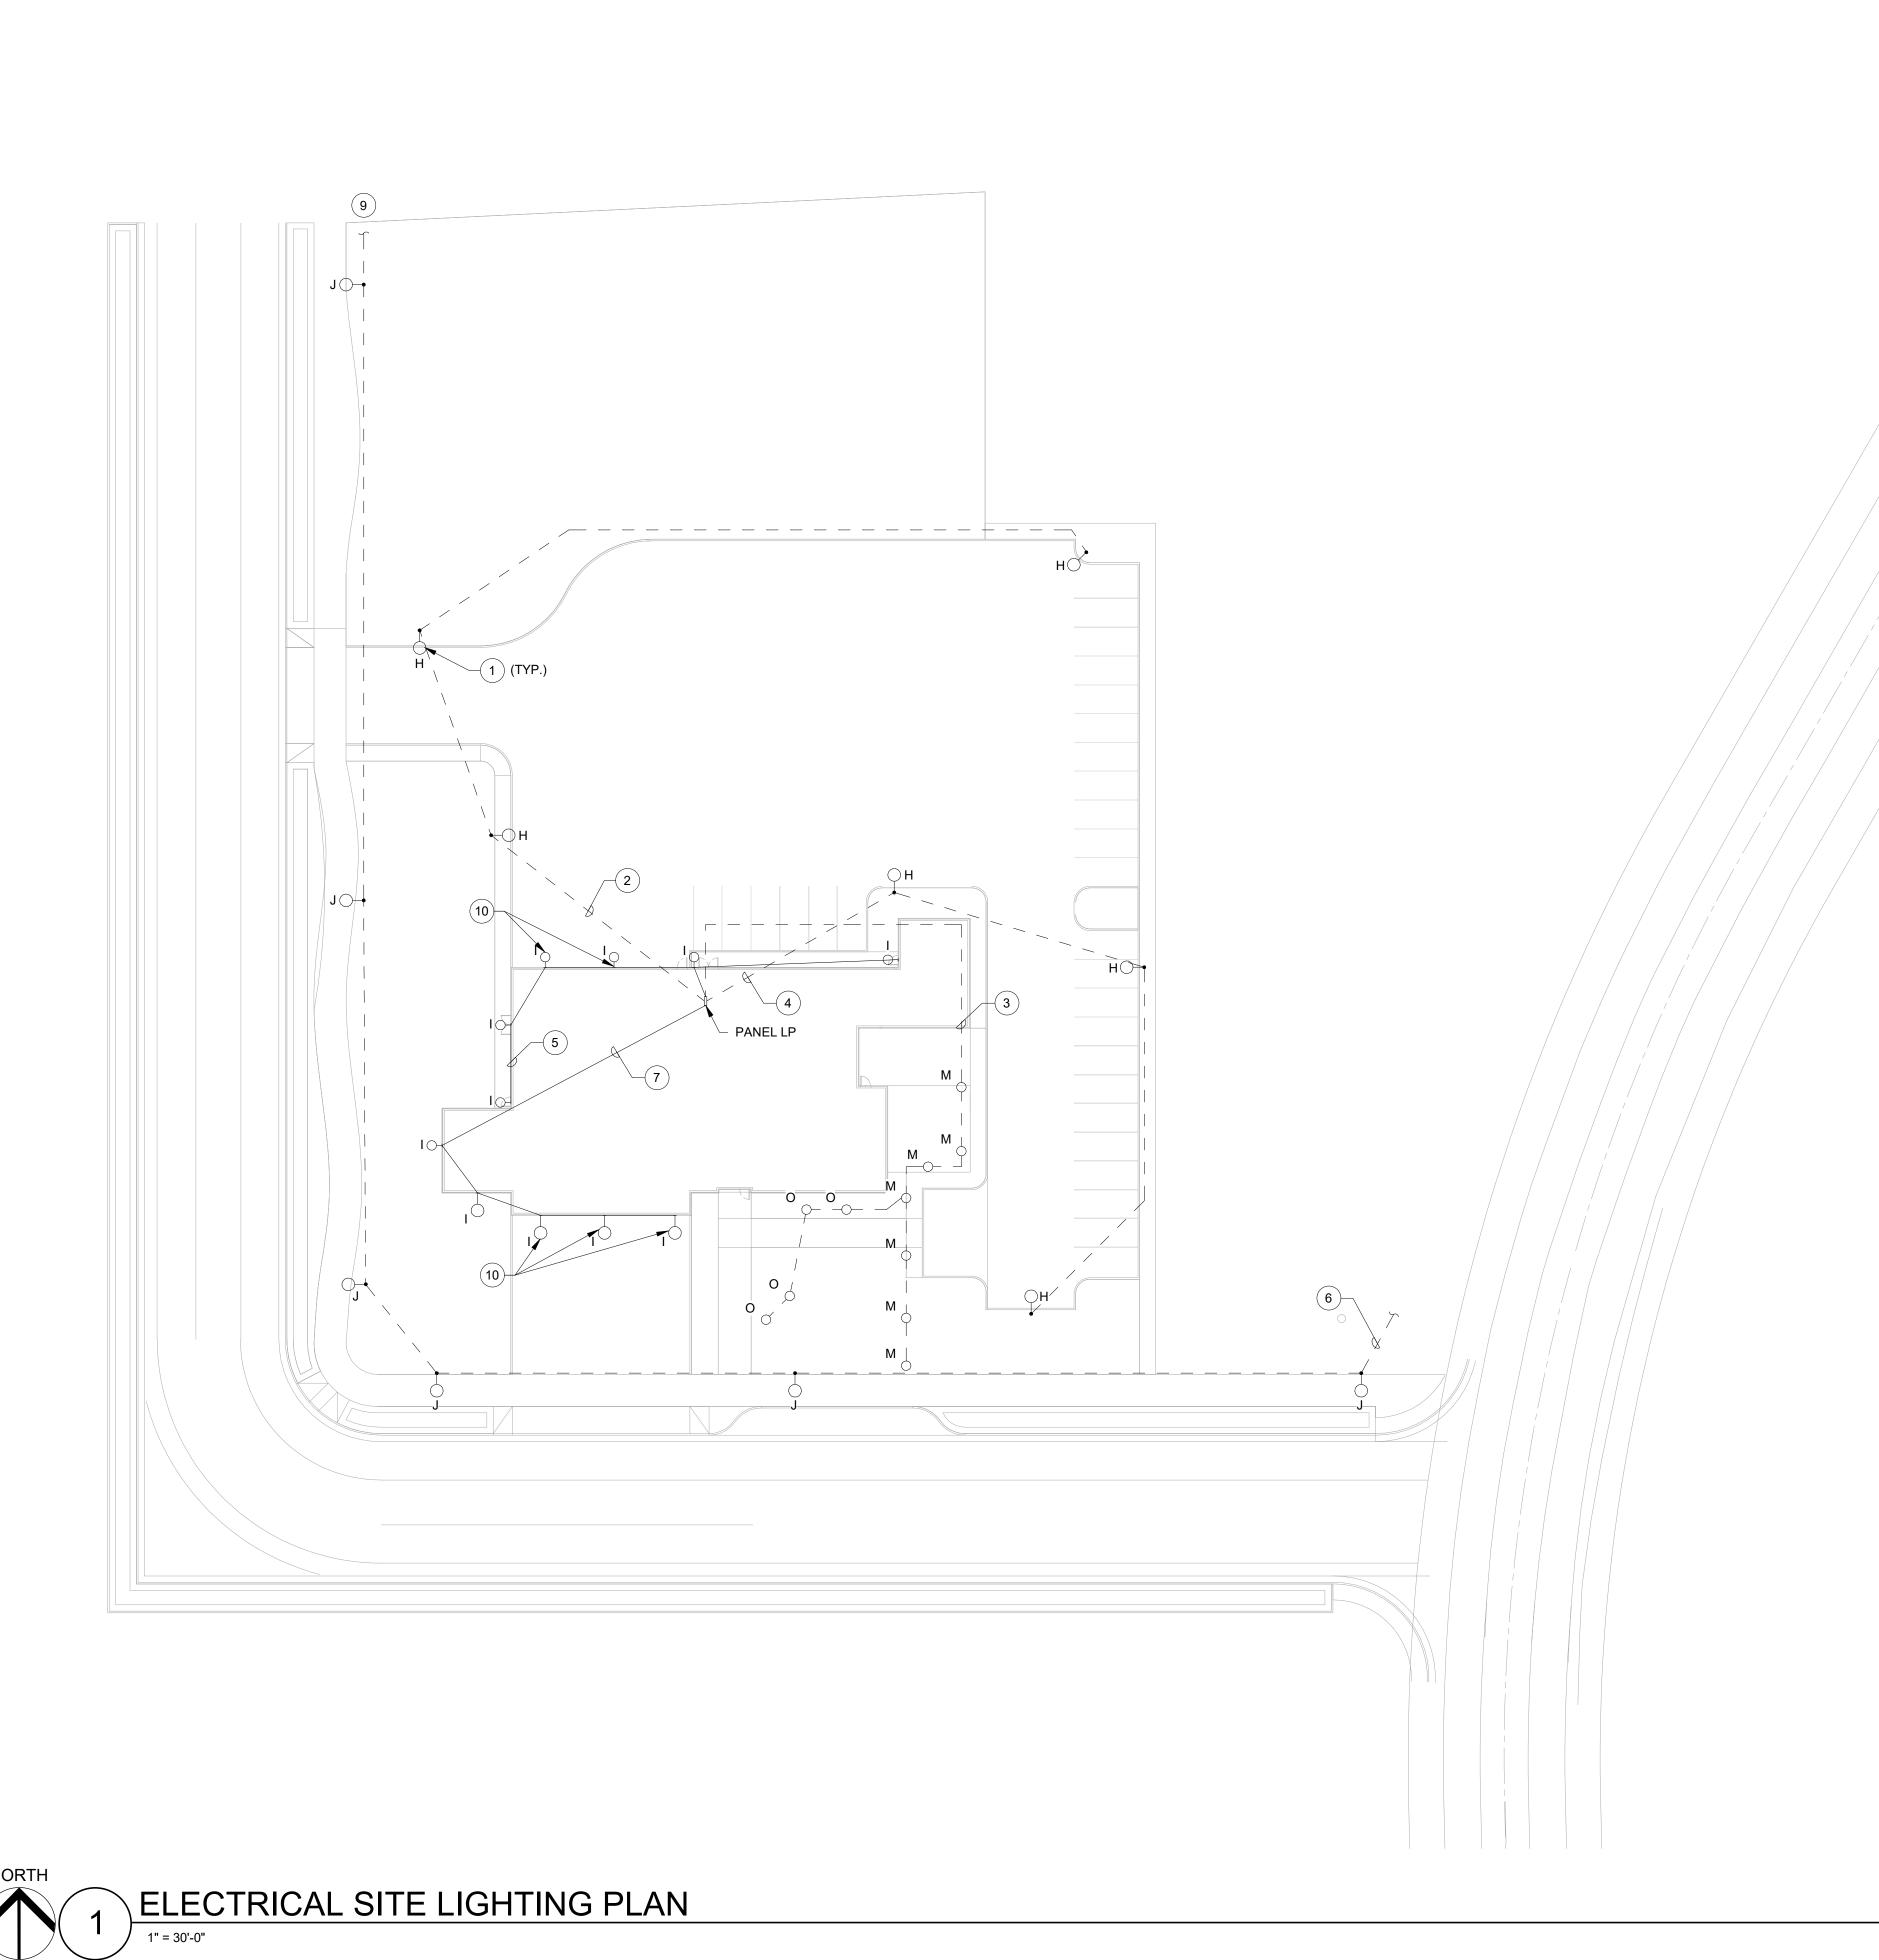
Drawing Title

/B/

ELECTRICAL SITE
LIGHTING PLAN

Sheet No

EL1.01



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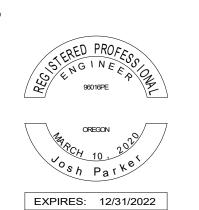


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02/03/21

CC20034

/B/

/A/

ELECTRICAL

LIGHTING GROUND FLOOR PLAN - WEST

EL1.02

1/8" = 1'-0"

ELECTRICAL LIGHTING ABOVE DORM AREA PLAN

A SEE SHEET E0.01 FOR LEGEND, ABBREVIATIONS, & GENERAL NOTES.

B CONTRACTOR TO COORDINATE/PROVIDE ALL REQUIRED INTERCONNECTION FOR COMPLETE LIGHTING CONTROL SYSTEM. WHAT IS SHOWN IS BASED ON PRELIMINARY COORDINATION AND NOT ALL INTERCONNECTIONS ARE SHOWN.

LEGEND

NBRG 8 KIT BRIDGE, KIT

RANGE 360° LENS

NPP16 D EFP

POWER/RELAY PACK, OCCUPANCY CONTROLLED DIMMING, EXTERNAL FAULT PROTECTION

NIO 1S KO

nLIGHT DEVICE, CONTACT CLOSURE INPUT, CHASE NIPPLE MOUNTING NCM PDT10

LOW VOLTAGE CEILING MOUNT SENSOR, PASSIVE DUAL TECHNOLOGY, LARGE MOTION / EXTENDED

Key Plan

NCM PDT 9 AR LOW VOLTAGE CEILING MOUNT SENSOR, PASSIVE DUAL TECHNOLOGY, SMALL MOTION / STANDARD RANGE 360° LENS, AUXILIARY RELAY

PL1 ARP INTEN16 NLT 16FCR MVOLT 1VB

ACUITY RELAY PANEL, INCLUDE INT AND ENC, 16-SIZE, nLIGHT, 16-FIELD CONFIGURABLE RELAYS, 120-277 VAC, 1 VOLTAGE BARRIER, SCRE COVER, SURFACE MOUNT

NPP20 PL PLUG LOAD

POWER SUPPLY, 80mA

NECY MVOLT ENC FGXK nLIGHT ECLYPSE, 120-277 VAC, 14 1/4"Hx14 1/4"Wx4"D METAL ENCLOSURE FOR ECLYPSE ENERGYSYTE OR nLIGHT ECLYPSE., NGWY2 GFX AND PS 150 POWER SUPPLY WITH CAT 5 CABLE

WSXA PDT XX WALL SWITCH SENSOR, PASSIVE DUAL TECHNOLOGY

/A/

SPODMRD XX WALL SWITCH DIMMER

NPODMA DX XX nLIGHT WIRED AESTHETIC WALLPOD, RAISE/LOWER DIMMING WITHOUT WIRES

RAISE/LOWER DIMMING WITHOUT WIRES

/B/

NPODMA 2P DX XX nLIGHT WIRED AESTHETIC WALLPOD, 2-POLE,

Architects

Soderstrom

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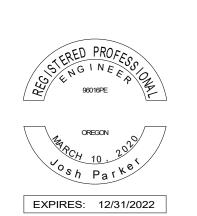
Beaverton, OR (503) 645-0176

01/11/21

02/03/21

Revisions No. Description 0 PERMIT SET

1 BID SET



BID SET

02/03/21

Project Number CC20034

Drawing Title

ELECTRICAL LIGHTING **CONTROLS PLAN**

EL1.03

- A SEE SHEET E0.01 FOR LEGEND, ABBREVIATIONS, & GENERAL NOTES.
- B ALL DATA CABLING TO BE CAT6.
- C DESIGN/BUILD SYSTEM COMPONENTS ON THIS PLAN INCLUDE ACCESS CONTROL & AUDIO (ALERT PAGING). THE INTENT OF THE DRAWINGS IS TO SHOW END DEVICE LOCATIONS AND TYPICAL INTERCONNECTION REQUIREMENTS. IT IS CONTRACTOR'S RESPONSIBILITY TO PROVIDE/INSTALL COMPLETE OPERATING SYSTEMS WHICH MEET OWNER REQUIREMENTS PER DRAWINGS AND DESIGN/BUILD SPECIFICATIONS. CONTRACTOR IS RESPONSIBLE FOR ALL LOW VOLTAGE PATHWAY, CABLING AND TERMINATIONS.
- D LED LIGHTS IN CEILING SPEAKERS ARE FED FROM THE TAP OUT UNIT, SEE
- E SEE SHEET E6.03 FOR TAP OUT SYSTEM INFORMATION

KEYED NOTES

- PROVIDE DEMARK BACKBOARD IN IT ROOM FOR TERMINATION OF FIBER AND COPPER CABLES. COORDINATE WORK WITH CENTURYLINK, LS NETWORKS AND XFINITY.
- 2 PROVIDE HID SIGNO 40K PROXIMITY CARD READER OR APPROVED EQUAL AT LOCATION SHOWN. PROVIDE SINGLE GANG BACKBOX AND SPARE 3/4" CONDUIT FROM CARD READER TO SITE HEAD-END EQUIPMENT IN IT CLOSET. PROVIDE POWER SUPPLY, CONTROL PANEL AND INTERCONNECTING LOW VOLTAGE CONDUCTORS AS REQUIRED FOR A COMPLETE OPERATING SYSTEM. COORDINATE WITH SECURITY VENDOR.
- PROVIDE OUTDOOR RATED CCTV CAMERA AS SHOWN. CAMERA TO HAVE INFRARED VISION IN DARKNESS, CONTAIN INTERNAL POWER SUPPLY, AND HAVE WIDE ANGLE VIEW. PROVIDE SPARE 3/4" CONDUIT FROM CAMERA TO SITE HEAD-END EQUIPMENT IN IT CLOSET. PROVIDE ALL INTERCONNECTING LOW VOLTAGE CONDUCTORS AS REQUIRED FOR A COMPLETE OPERATING SYSTEM. COORDINATE WITH SECURITY VENDOR. COORDINATE FINAL LOCATION WITH OWNER.
- 4 PROVIDE 1" CONDUIT FROM JUNCTION BOX TO EMERGENCY PHONE AND INTERCOM CONNECTION POINT. COORDINATE WITH SECURITY CONTRACTOR.
- 5 COORDINATE LOCATIONS OF GAS SOLENOID SHUT-OFF VALVES FOR NOTED RANGE AND BBQ WITH THE PLUMBING CONTRACTOR. VALVES TO REMAIN CLOSED UNTIL RESET BUTTON IS ENGAGED.
- 6 COORDINATE LOCATIONS OF NOTED GAS RANGE/OVEN AND BBQ APPLICANCE RESET BUTTONS WITH OWNER.
- 7 PROVIDE WALL MOUNTED CONTROL KNOB TO ALLOW CONTROL OF SPEAKER VOLUME IN THE ROOM.
- 8 PROVIDE WEATHERPROOF SPEAKER, SPEAKER TO BE ON TIMER TO ALLOW FOR CONTROL DURING OWNER SPECIFIED HOURS. COORDINATE WITH TAP OUT SYSTEM INSTALLER. COORDINATE FINAL LOCATION WITH
- PROVIDE 2 1/2" RIGID STEEL CONDUIT FROM IT ROOM RADIO BASE STATION TO 6' ABOVE ROOF PEAK FOR FUTURE HAM RADIO ANTENNA, CAP AND SEAL FOR FUTURE USE. CONSULT WITH OWNER FOR MORE
- 10 PROVIDE 2 1/2" RIGID STEEL CONDUIT FROM MEETING ROOM WALL TO 6' ABOVE ROOF PEAK FOR OWNER PROVIDED ANALOG RADIO ANTENNA. CONSULT WITH OWNER FOR MORE INFORMATION.

/B/

11 PROVIDE 2 1/2" RIGID STEEL CONDUIT FROM IT ROOM RADIO BASE STATION TO 6' ABOVE ROOF PEAK FOR OWNER PROVIDED DIGITAL RADIO ANTENNA. CONSULT WITH OWNER FOR MORE INFORMATION.

Key Plan

/A/

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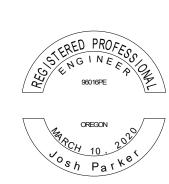


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Revisions



BID SET

02/03/21

CC20034

ELECTRICAL LOW VOLTAGE GROUND FLOOR PLAN - WEST

EV1.01

ELECTRICAL LOW VOLTAGE GROUND FLOOR PLAN - WEST