GORDON TRUCKS

BEAVERTON, OREGON 97005 0 | 503.244.0552

NOT FOR

CONSTRUCTION

MILLERSBURG EXPANSION

ZONING ANALYSIS - CITY OF MILLERSBURG

NOTE: REFERENCE SITE PLAN FOR DEMONSTRATION OF COMPLIANCE ARTICLE II - ZONES AND ZONING REGULATION ZONING - LI LIGHT INDUSTRIAL

<u>CHAPTER 2.09.020 - CONDITIONAL USES FOR LI</u>
(5) MANUFACTURING, PROCESSING STORAGE OF EXPLOSIVES, OR EPCRA SECTION 302 - EXTREMELY HAZARDOUS SUBSTANCES WHEN LOCATED WITHIN 300 FEET OF RESIDENTIALLY ZONED LAND. (6) REPAIR AND MAINTENANCE OF VEHICLES ON COMMERCIAL CHASSIS AND COMMERCIAL EQUIPMENT, WHEN REPAIRS ARE CONDUCTED INSIDE A STRUCTURE. THE OUTDOOR STORAGE OF DISASSEMBLED OR DAMAGED VEHICLES. IN SIGHT OF A (7) SALES OF NEW AND USED CLASS 4 THROUGH 10 COMMERCIAL VEHICLES. THE SALE OF USED COMMERCIAL VEHICLES

BUILDING SETBACK: 5' SETBACK BETWEEN ANY BUILDING AND THE PROPERTY LINE. FRONT SETBACK (NONE REQUIRED): EXISTING BUILDING 60' FROM THE PROPERTY BOUNDARY, SEE SITE PLAN SIDE/ REAR SETBACK: NONE REQUIRED

ADJACENT TO R ZONES SHALL BE 10' + 5' PER STORY: NOT APPLICABLE BUILDING HEIGHT (50' MAX): BUILDING #A 39'- 1-3/8". BUILDING #B 43' (PROPOSED

LOT COVERAGE: PROPOSED 81.3% (90% MAX)

PROPERTY AREA: 984,215.57 SF (22.6 ACRES) BUILDING COVERAGE: (63,850 + 112,320) / 984,215.57 = 17.9% PARKING LOT COVERAGE: 623915.15 / 984,215.57 = 63.4%

STREET STANDARD:

A MINIMUM OF 300' DISTANCE BETWEEN DRIVEWAY 5' WIDE SIDEWALK ALONG THE PROPERTY FRONTAGE WITH OLD SALEM ROAD SHALL BE REQUIRED: MIN. 5' PROVIDED STREET TREE SHALL BE PROVIDED, REFER TO LANDSCAPE PLAN. EXISTING BIKE LANE SHALL BE REMAINED.

<u>VEHICLE PARKING</u> <u>CHAPTER 3.03, TABLE 14 - OFF-STREET PARKING AND LOADING REQUIREMENTS</u>

DIMENSIONS, 2-WAY, 90-DEG: 9.0'W X 20.0'L, 24.0' AISLE 8.5'W X 18.0'L, 24.0' AISLE, COMPACT (UP TO 20%)

(L): OFFICE BUILDING

(K): SERVICE OR REPAIR SHOP

MIN: 1/800 SF + 1 SPACE PER 2 EMPLOYEES MAX: MIN + 30%

(P): MANUFACTURING AND PROCESSING 25000-49999 SF MIN: 1/700 SF (Q): WAREHOUSING AND STORAGE DISTRIBUTION 0-49999 SF

MIN: 1/3000 SF (Q): WAREHOUSING AND STORAGE DISTRIBUTION 50,000 SF AND OVER

MIN: 1/5000 SF

BICYCLE PARKING DIMENSIONS: 2.0'W X 6.0'L ACCESSIBLE BY A MINIMUM FIVE FOOT AISLE LOCATION SHALL BE WITHIN 100' OF THE BUILDING ENTRANCE

(L): OFFICE BUILDING 1 PER 20 VEHICLE SPACES (K) SERVICE OR REPAIR SHOP AND RETAIL: 1 PER 30 VEHICLE SPACES (P): MANUFACTURING AND PROCESSING 25000-49999 SF: 1 PER 20 VEHICLE SPACES (Q): WAREHOUSING AND STORAGE DISTRIBUTION 0-49999 SF: 1 PER 30 VEHICLE SPACES

(Q) WAREHOUSING AND STORAGE DISTRIBUTION 50,000 SF AND OVER: 1 PER 30 VEHICLE SPACES

CHAPTER 3.03.070 - OFF-STREET LOADING REQUIREMENTS (1) 10,000-25,000 SF = 1

(1) EA ADDITIONAL 25,000 SF = 1 MIN: 12.0'W X 30.0'L X 14.0'H

THE PROJECT PARKING PROPOSES AS FOLLOWS PER 3.03 TABLE 14: BUILDING A (12000+48850+3000= 63,850 SF)

WAREHOUSE AND STORAGE (MAIN LEVEL): (8000/3000) = 2.6 PARKING SPACES SERVICE AND SUPPORT (MAIN AND UPPER LEVEL): (4000/800) = 5 PARKING SPACES

NEW ADDITION WAREHOUSE AND STORAGE (MAIN LEVEL): (3638/3000) = 1.2 PARKING SPACES

SERVICE AND SUPPORT (MAIN LEVEL): (6800/800) = 8.5 PARKING SPACES SERVICE AND SUPPORT (UPPER LEVEL): (3000/800) = 3.75 PARKING SPACES

EMPLOYEE: (66/2) = 33*SERVICE BAY: (38,412/800)=48 (SEE NOTE BELOW)= 14 PARKING SPACES + 34 OVERSIZE PARKING SPACE

*CHAPTER 3.03 TABLE 14 IS NOT APPLICABLE FOR THE 38,412 SQFT OF THE SERVICE BAY AS THE SERVICE CUSTOMER ARE USING THE OVERSIZE PARKING SPOTS. IN ADDITION TO PROVIDING 14 REGULAR VEHICLE PARKING SPOTS, 34 OVERSIZE PARKING ARE AVAILABLE ON-SITE FOR THE SERVICE BAY CUSTOMER; SEE THE SITE PLAN.

BUILDING A AND EXISTING

BUILDING#A TOTAL PARKING SPACES REQUIRED = 68.13 (69 PROVIDED)

ASSUME OFFICE SPACE: (6000/400) = 15 PARKING SPACES ASSUME WAREHOUSE SPACE: (75792/5000) = 15.16 PARKING SPACES ASSUME MANUFACTURING SPACE: (30528/700) = 43.61 PARKING SPACES

BUILDING#B TOTAL PARKING SPACES REQUIRED = 73.77 (75 PROVIDED)

PER OSSC TABLE 1106.1, TOTAL PARKING SPACES 51-75 REQUIRED 2 STANDARD ACCESSIBLE 1 VAN ACCESSIBLE

STANDARD ACCESS

BUILDING A: TOTAL BIKE PARKING SPACE: (68.13/30) 2.3 REQUIRED (3 PROVIDED) BUILDING B: TOTAL BIKE PARKING SPACE: ((15/20) +(15.16/30)+ (43.61/20)) 3.44 REQUIRED (8 PROVIDED)

GORDON TRUCK CENTERS

CONTACT PERSON: DOMINIC NICANDRI

MILDREN DESIGN GROUP, P.C.

EMAIL: dominic.nicandri@gordontruckcenters.com

277 STEWARD ROAD

PACIFIC, WA 98047

Architect:

OFF-STREET LOADING:

PROJECT TEAM

BUILDING A: (63850/25000)= 2.6 REQUIRED, 3 PROVIDED BUILDING B: (112320/25000)= 4.49 REQUIRED, 5 PROVIDED

<u>ELECTRIC VEHICLE CHARGING STATION INFRASTRUCTURE</u> SHALL BE PROVIDED IN ACCORDANCE WITH DIVISION 460 STRUCTURAL AND ENERGY EFFICIENCY SPECIALTY CODES SECTION 918-460-0200. CONTRACTOR TO VERIFY REQUIREMENTS AND COMPLY WITH MOST CURRENT REQUIREMENTS BUILDING#A TOTAL PARKING SPACES REQUIRED = 69 X 20% = 13.8 (14 EV CHARGING INFRASTRUCTURE SHALL BE PROVIDED) <u>BUILDING#B TOTAL PARKING SPACES REQUIRED = 75 X 20% = 15 (15 EV CHARGING INFRASTRUCTURE SHALL BE PROVIDED)</u>

FIRE PROTECTION

S-1 OCCUPANCY:

F-1 OCCUPANCY:

FREEZE PROTECTION:

SMOKE AND HEAT VENTS:

BUILDING CODE ANALYSIS

GOVERNING CODES 2019 OREGON OREGON STRUCTURAL SPECIALTY CODE (OSSC) 2019 OREGON FIRE CODE (IFC 2018 WITH AMENDMENTS) 2019 OREGON MECHANICAL SPECIALTY CODE (OMSC) 2019 OREGON ELECTRICAL SPECIALTY CODE (OESC) 2019 OREGON PLUMBING SPECIALTY CODE (OPSC)

2021 OREGON ENERGY EFFICIENCY SPECIALTY CODE (OEESC) 2016 NFPA 13 STANDARD FOR INSTALLATION OF SPRINKLER SYSTEMS 2016 NFPA 72 NATIONAL FIRE ALARM AND SIGNALING CODE 2016 NFPA 110 STANDARD FOR EMERGENCY AND STANDBY POWER SYSTEMS

BUILDING A

OCUPANCY AND CONSTRUCTION CONSTRUCTION TYPE:

BUILDING A: IIB **REQUIRED SEPARATION:** B,S-1,F-1 NO SEPARATION REQUIREMENT PER OSSC SECTION 508.3

B, S-1, F-1

B, F-1, S-1: 75'

PER IBC 304, 306, 311 AND 602.2

PER OSSC TABLES 504.3, 504.4, 506.2

0 HRS

0 HRS

0 HRS

BUILDING HEIGHT AND AREA ALLOWABLE HEIGHT: ALLOWABLE STORIES:

2010 ADA STANDARDS FOR ACCESSIBLE DESIGN

F-1, S-1: 3 PROPOSED HEIGHT: 39'- 1-3/8" (APPROXIMATE)< 75', OKAY

PROPOSED STORIES: 2 < 3,4 OKAY ALLOWABLE AREA: F-1 (SM): 46,500 SF

II-B ONE STORY SPRINKLERED S-1 (SM): 52,500 SF B (SM): 69,000 SF

UNLIMITED BUILDING AREA PER OSSC 507.2.1 & 507.4 ACTUAL BUILDING AREA:

REQUIRED SEPARATION:

FLOOR CONSTRUCTION:

ROOF CONSTRUCTION:

OCUPANCY AND CONSTRUCTION ASSUMED OCCUPANCY:

PER IBC 304, 306, 311 AND 602.2 B, S-1, F-1 **CONSTRUCTION TYPE:** BUILDING B: IIIB B,S-1,F-1 NO SEPARATION REQUIREMENT PER OSSC SECTION 508.3

BUILDING HEIGHT AND AREA ALLOWABLE HEIGHT: PER OSSC TABLES 504.3, 504.4, 506.2 B,F-1, S-1: 75'

ALLOWABLE STORIES: F-1, S-1: 3

PROPOSED HEIGHT: 43' (VERIFY)< 75', OKAY PROPOSED STORIES: 1 < 3,4 OKAY

ALLOWABLE AREA: F-1 (S1): 48,000 SF II-B ONE STORY SPRINKLERED S-1 (S1): 70,500 SF B (S1): 76,000 SF

UNLIMITED BUILDING AREA PER OSSC 507.2.1 & 507.4 ACTUAL BUILDING AREA:

FIRE-RESISTANCE RATING REQUIREMENTS PER OSSC TABLE 601 AND 602 STRUCTURAL FRAME

EXTERIOR BEARING WALLS: 0 HRS EXTERIOR NON-BEARING WALLS: 0 HRS INTERIOR NON-BEARING WALLS: 0 HRS

OPENING PROTECTION IN EXTERIOR WALLS: PER OSSC TABLE 705.8 > 30 FT NO LIMIT, UNPROTECTED/ NONSPRINKLERED

0 HRS

0 HRS

MILLERSBURG, OREGON

PROJECT SUMMARY

THIS PROPOSED DEVELOPMENT BUILDING A SCOPE IS AN APPROXIMATELY 48,850 SF COMMERCIAL EXPANSION OF AN EXISTING 12,000 SF COMMERCIAL BUILDING WITH B, F-1 AND S-1 OCCUPANCIES. THE BUILDING WILL BE CONSTRUCTED OF METAL FRAME WITH INTERIOR OFFICE, SERVICE AND SALES ALONG WITH SHIPPING AND STORAGE. THE BUILDING WILL WAREHOUSE AREA OF 3.638 SF. THE BUILDING A WILL HAVE APPROXIMATELY 69 PARKING SPACES INCLUDING 3 ADA WILL INCLUDE AREAS FOR TRUCK DISPLAY FOR SALES, OVER-SIZED VEHICLE PARKING, AND TRACTOR TRAILER PARKING WITH APPROPRIATE CIRCULATION. ACCESS TO THE SITE WILL BE VIA OLD SALEM ROAD. THE BUILDING WILL BE

THE PROJECT ALSO PROPOSES BUILDING B, THE NEW CONSTRUCTION OF A SINGLE STORY BUILDING, SHELL ONLY, ASSUME OCCUPANCY S1-F AND B PERMIT WITH ASSOCIATED PARKING, LANDSCAPE AND UTILITIES. TOTAL PROPOSED BUILDING SQUARE FOOTAGE IS APPROXIMATELY 112,320 SF. THE BUILDING IS PROPOSED AS A TILT-UP CONCRETE TYPE III-B

LOT DESCRIPTION

MAP & TAX LOT ID # 10S03W21-00304 and 00305

5801 OLD SALEM RD NE. NE 1/4 SEC 21, T.10S, R3W, W.M., CITY OF MILLERSBURG, LINN COUNTY, OREGON.

SHEET INDEX

BUILDING IS EQUIPPED WITH AN AUTOMATIC FIRE PROTECTION SYSTEM

1006.2.1: <49 OCC, COMMON PATH OF EGRESS < 100'-0" (SPRINKLERED)

1006.2.1: <29 OCC, COMMON PATH OF EGRESS < 100'-0" (SPRINKLERED)

1006.2.1: <29 OCC, COMMON PATH OF EGRESS < 100'-0" (SPRINKLERED)

THERMOSTAT HAVING A MAXIMUM SET POINT CAPACITY OF 45°F MOUNTED

GAS FIRED UNIT HEATING SYSTEM LOCATED IN WAREHOUSE WITH A

NOT LOWER THAN THE HEATING UNIT WITH AN OUTPUT CAPACITY NOT

1017.2: EXIT ACESS TRAVEL DISTANCE < 300'-0" (SPRINKLERED)

1017.2: EXIT ACESS TRAVEL DISTANCE < 250'-0" (SPRINKLERED)

1017.2: EXIT ACESS TRAVEL DISTANCE < 250'-0" (SPRINKLERED)

EXCEEDING 15 Btu/hr.ft2 OR 4 Watts/ft2 OF HEATED FLOOR AREA.

HAZARD CLASSES 1-4, WITH AN INTERIOR CLEAR HEIGHT OF 18'-0"

RESPONSIBILITY OF PEMB MANUFACTURER

CLASS C - ROOMS AND ENCLOSED SPACES

THROUGHOUT IN IAW WITH OSSC 903.3.1.1 AND DESIGNED TO ACCOMMODATE

		6/21/2023
		DESIGN REVIEW -
		<u> </u>
NUMBER	SHEET NAME	
00 DESIGN		
00.1	COVERSHEET	
00.2	OVERALL SITE AERIAL RENDERING	
00.3	BIRD'S EYE VIEW	
00.4	BUILDING A RENDERING	
00.5	BUILDING B RENDERING	
1 GENER		
G1.0	SITE SURVEY AND EXISTING CONDITIONS	
2 CIVIL		
C0	CIVIL - GENERAL NOTES	
C1	CIVIL - EXISTING CONDITIONS AND DEMOLITION PLAN	
C2	CIVIL - PRELIMINARYGRADING PLAN	•
C3	CIVIL - PRELIMINARY PROFILES	•
C4	CIVIL - PRELIMINARY STORM PLAN	
C5	CIVIL -PRELIMINARY SEWER AND WATER PLAN	
C6	CIVIL -PRELIMINARY FIRE PLAN	
C7 C8	CIVIL - PRELIMINARY POWER AND FRANCHISE UTILITIES CIVIL - PRELIMINARY LOT ADJUSTMENT PLAN	
3 LANDSO		•
L1.0	LANDSCAPE PLAN	
L1.1	ENLARGED LANDSCAPE PLAN	
L1.2	ENLARGED LANDSCAPE PLAN	
L1.3	ENLARGED LANDSCAPE PLAN	_
L1.4	ENLARGED LANDSCAPE PLAN	
L2.0	LANDSCAPE SPECS & DETAILS	
4 FIRE		-
FD-1	SITE PLAN - FIRE RESPONSE	
5 ARCHIT	ECTURAL	
0A1.1	SITE PLAN	
0A1.3	SITE DETAILS	•
0A1.4	SITE DETAILS	
1A2.1	FLOOR PLAN, OVERALL BLDG A	•
1A2.5	ROOF PLAN BLDG A	
1A3.1	ELEVATIONS BLDG A	
1A3.2	EXTERIOR MATERIALS BLDG A	
1A4.1	OVERALL BUILDING SECTIONS BLDG A	
1A4.2	WALL SECTIONS BLDG A	
2A2.1	FLOOR PLAN, OVERALL BLDG B	
2A2.5	ROOF PLAN BLDG B	
2A3.1 2A3.2	ELEVATIONS BLDG B EXTERIOR MATERIALS BLDG B	
2A3.2 2A4.1	OVERALL BUILDING SECTIONS BLDG B	_
2A4.1 2A4.2	WALL SECTIONS BLDG B	I
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Client/ Owner:

GORDON TRUCK

CLIENT ADDR

GORDON **MILLERSBURG**

5801 NE OLD SALEM MILLERSBURG, OR

COVERSHEET

Revisions:

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VICINITY MAP



PROJECT SITE

Job Number Sheet

DESIGN REVIEW - JUNE 2023

VOICE: 503-244-0552 FAX: 503-244-0417 CONTACT PERSON: JEFF WILDER EMAIL: jeff@mdgpc.com

4875 SW GRIFFITH DRIVE, SUITE 300 BEAVERTON, OR 97005

Civil Engineer:

BUILDING B

SISUL ENGINEERING 375 PORTLAND AVENUE GLADSTONE, OR 97027

Structural Engineer:

CONTACT PERSON: TOM SISUL EMAIL: tomsisul@sisulengineering.com

T.M. RIPPEY CONSULTING ENGINEERS 7650 SW BEVELAND ST, SUITE 100 TIGARD, OR 97223 CONTACT PERSON: RALPH TURNBAUGH EMAIL: RTurnbaugh@TMRippey.com

FIRST FORTY FEET PORTLAND, OR 97209 CONTACT PERSON: WILL GRIMM EMAIL: will@firstfortyfeet.com

Landscape Architect: **OTTEN + ASSOCIATES**

3933 SOUTH KELLY AVENUE, SUITE B PORTLAND, OR 97239 CONTACT PERSON: ERIN HOLSONBACK EMAIL: erin@ottenla.com

BARKER SURVEYING

Surveyor

3657 KASHMIR WAY SE SALEM, OR 97317 CONTACT PERSON: GREGORY WILSON EMAIL: info@barkerwilson.com

TBD

General Contractor:





CONSTRUCTION

NOT FOR

GORDON
TRUCK
CENTERS

CLIENT ADDR

BUILDING ADDITION

5801 NE OLD SALEM ROAD MILLERSBURG, OR

Sheet Title:

OVERALL SITE AERIAL RENDERING

Revisions:

Description

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Date: 6/20/2023

Job Number: 121143

Sheet

Sileet



Client/ Owner: GORDON TRUCK CENTERS

CLIENT ADDR

BUILDING **ADDITION**

5801 NE OLD SALEM ROAD MILLERSBURG, OR

Sheet Title:

BIRD'S EYE VIEW

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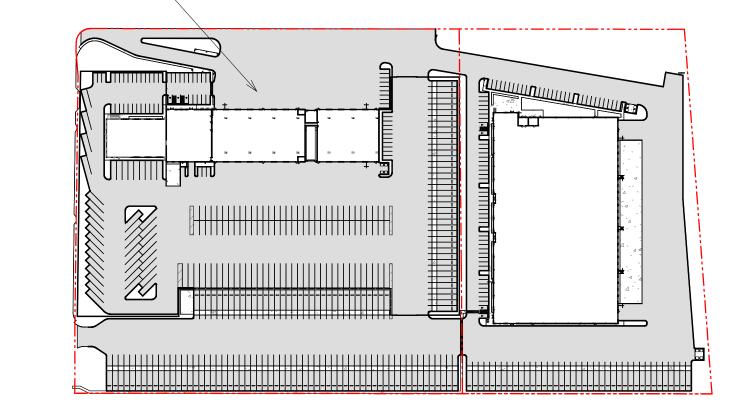
6/20/2023

121143

Sheet



BIRD'S EYE VIEW OF THE SITE -



DESIGN REVIEW - JUNE 2023 00.3





Client/ Owner:

GORDON TRUCK CENTERS

CLIENT ADDR

BUILDING **ADDITION**

5801 NE OLD SALEM ROAD MILLERSBURG, OR

Sheet Title:

BUILDING A RENDERING

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GORDON TRUCK CENTERS

CLIENT ADDR

BUILDING ADDITION

5801 NE OLD SALEM ROAD MILLERSBURG, OR

Sheet Title:

BUILDING B RENDERING

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GORDON TRUCK CENTERS

CENTE

CLIENT ADDR

BUILDING ADDITION

5801 NE OLD SALEM ROAD MILLERSBURG, OR

Sheet Title:

SITE SURVEY AND EXISTING CONDITIONS

Revisions:

Description


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Date: 6/20/2023

Job Number: 121143

NORTH She



REFER TO C1 FOR EXISTING CONDITION AND DEMOLITION PLAN

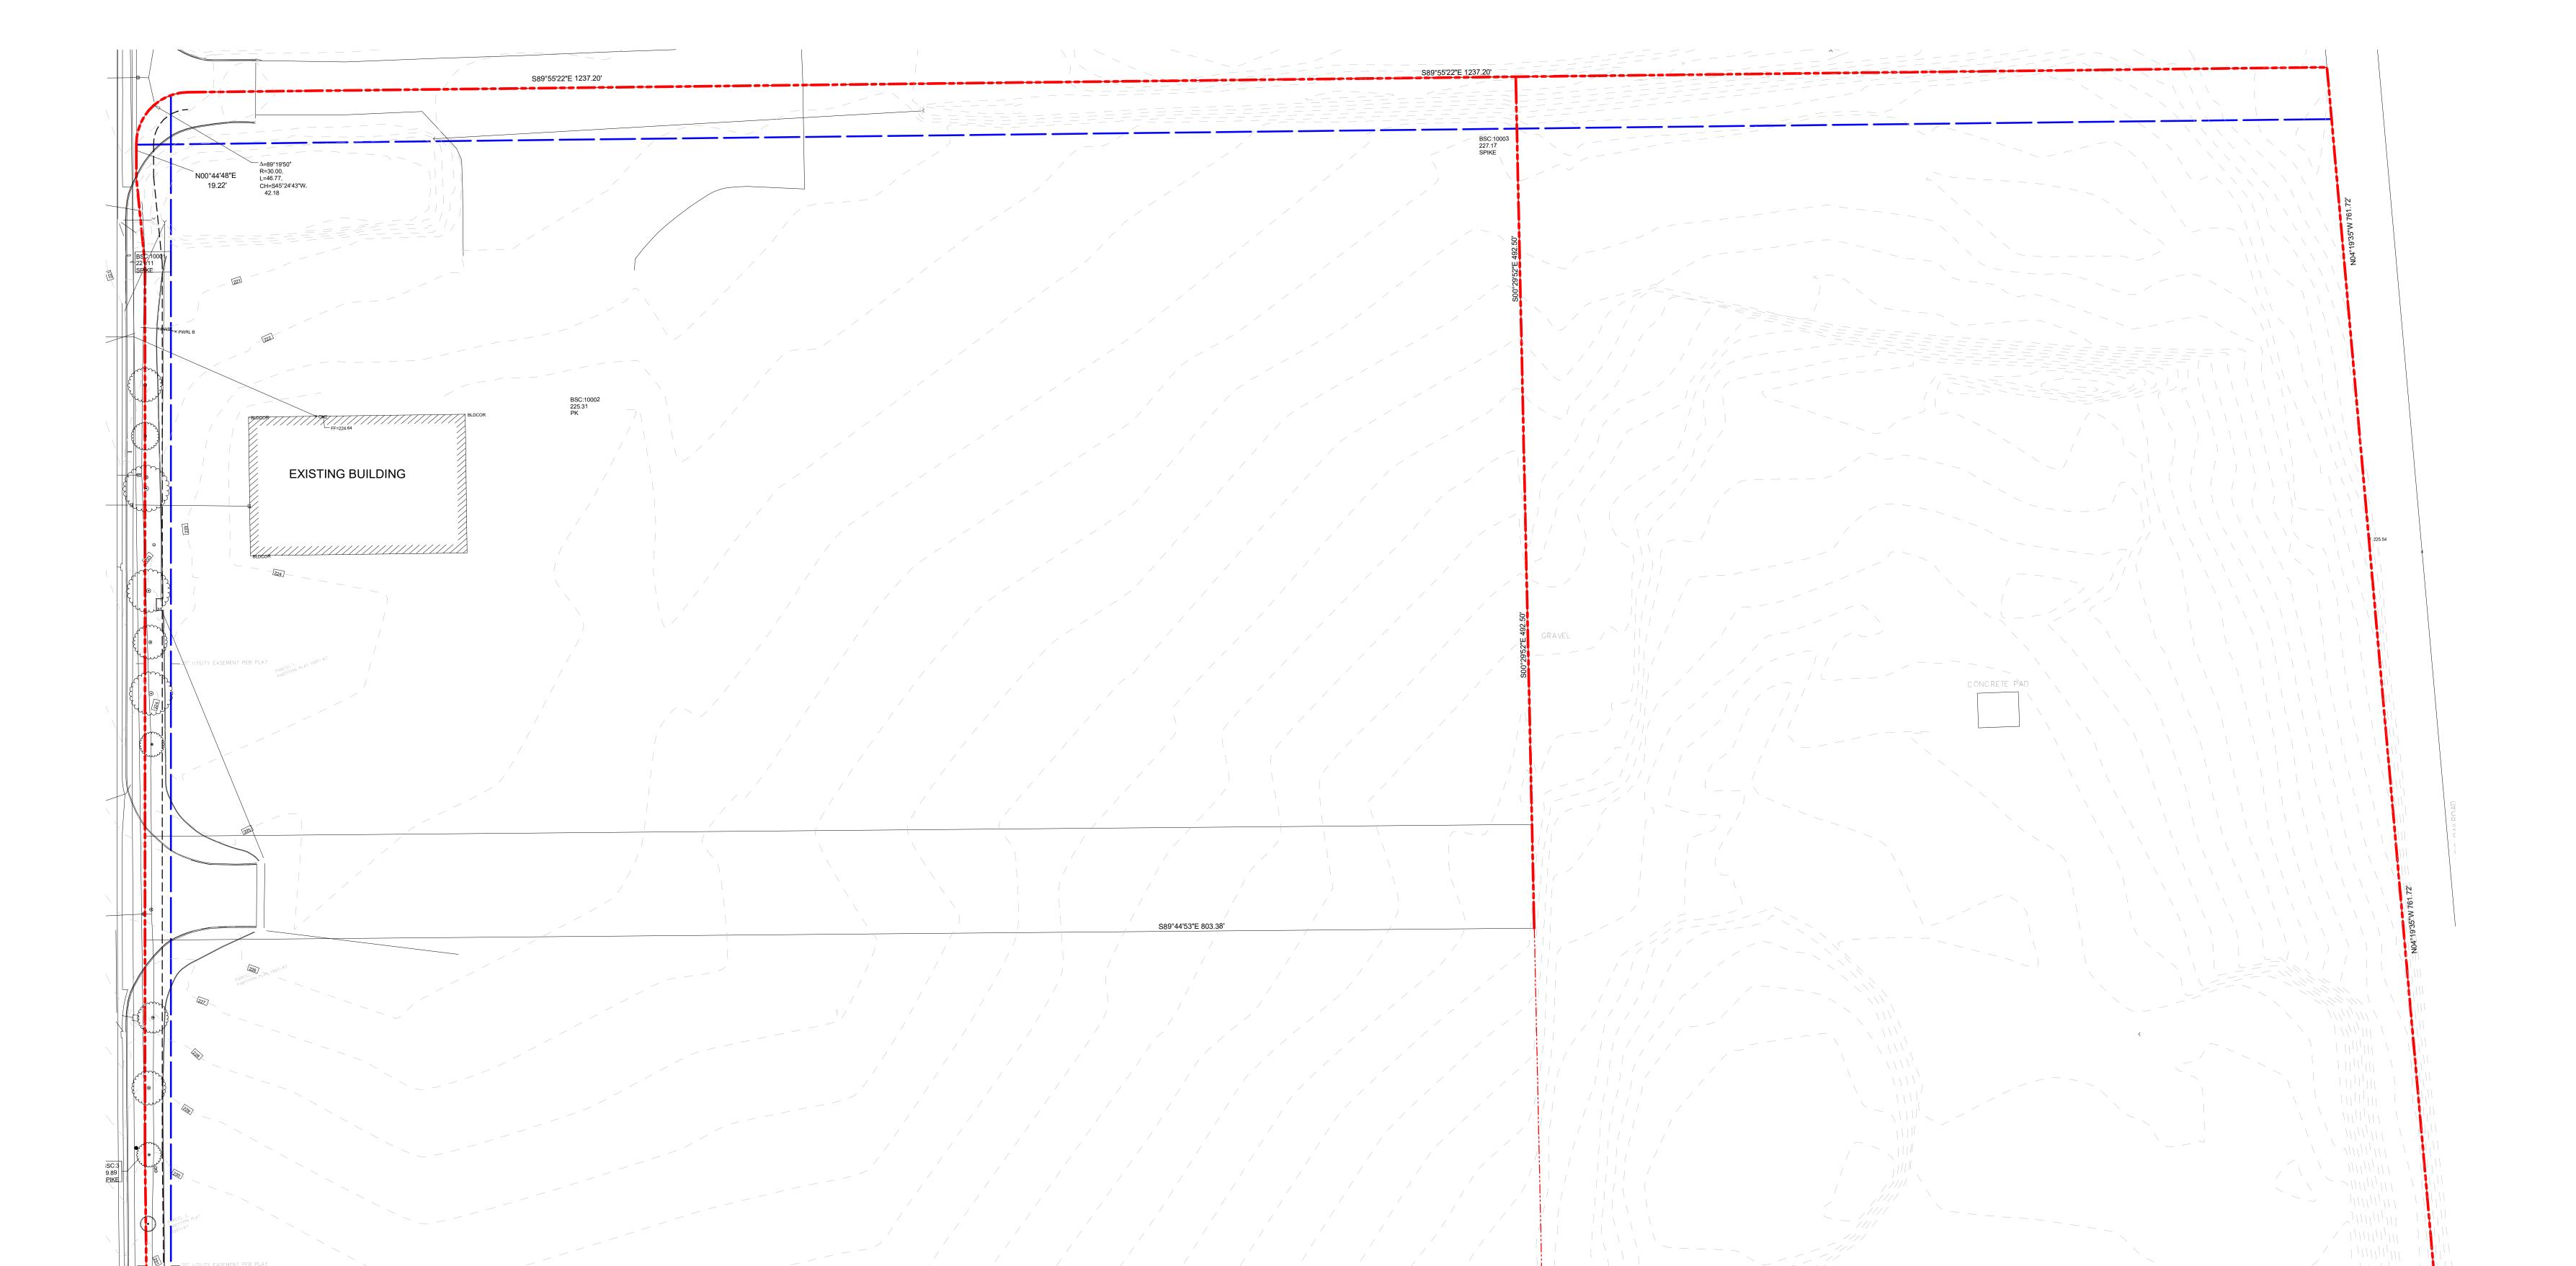N89°56'18"W 1327.47'

GORDON TRUCK CENTER 5801 OLD SALEM ROAD, ALBANY OR

CIVIL ENGINEER:

FEB 2023

SISUL ENGINEERING


375 PORTLAND AVE.
GLADSTONE, OR. 97027
(503) 657-0188
CONTACT: TOM SISUL

EMAIL: TOMSISUL@SISULENGINEERING.COM

DEVELOPER:


GORDON TRUCK CENTER

277 STEWARD RD PACIFIC, WA. 98047

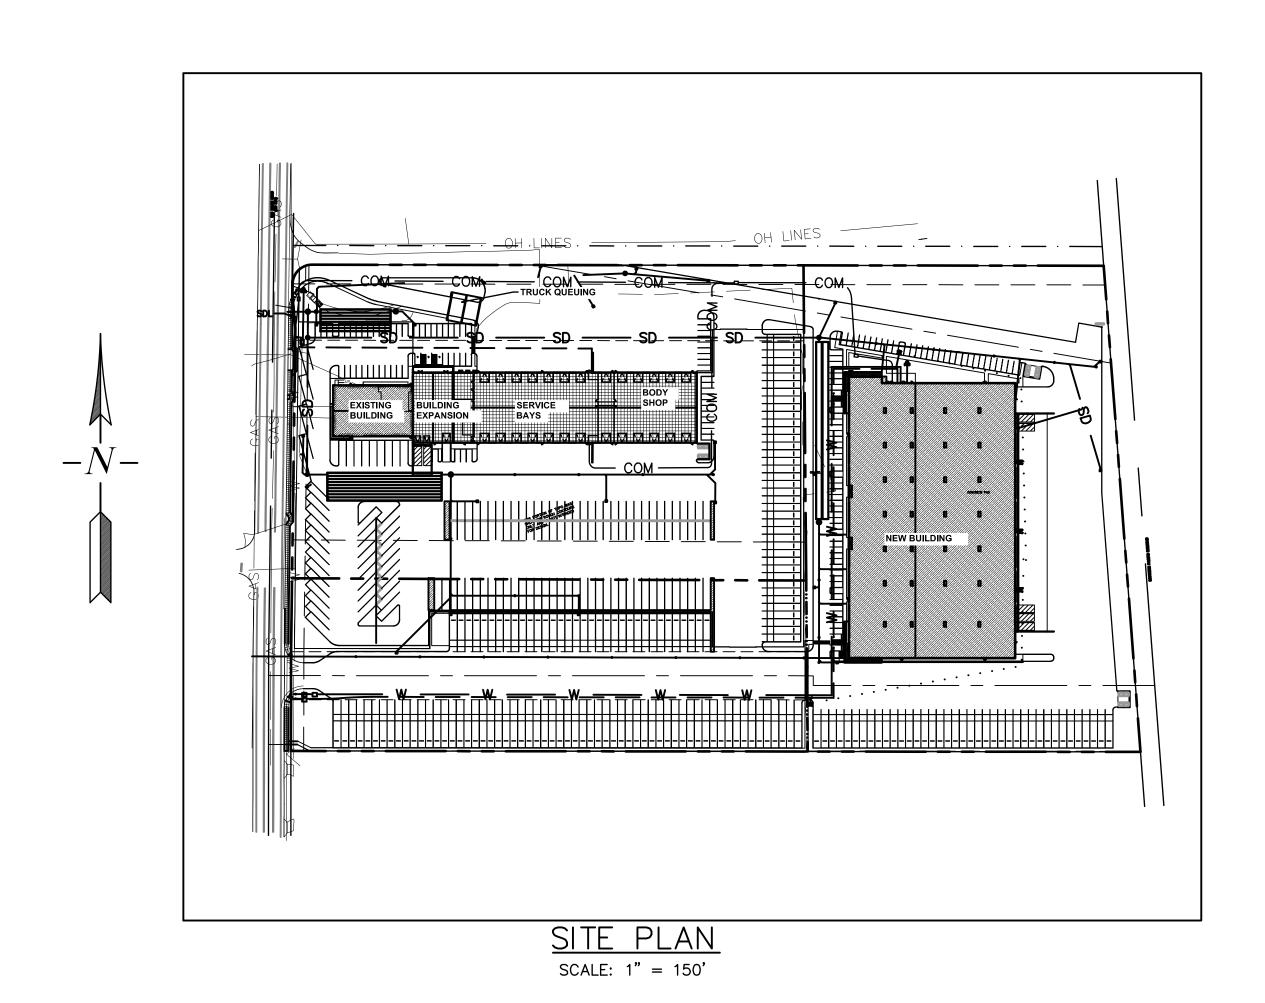

ATTENTION EXCAVATORS: OREGON LAW REQUIRES COMPLIANCE WITH OAR 952-001-0010 THROUGH 952-001-0090. THESE RULES MAY BE OBTAINED BY CALLING OREGON UTILITY NOTIFICATION CENTER (503) 232-1987. YOU MUST NOTIFY THE CENTER AT LEAST TWO WORKING DAYS BEFORE, BUT NOT MORE THAN TEN DAYS PRIOR TO EXCAVATION.

CALL BEFORE YOU DIG (503) 246-6699

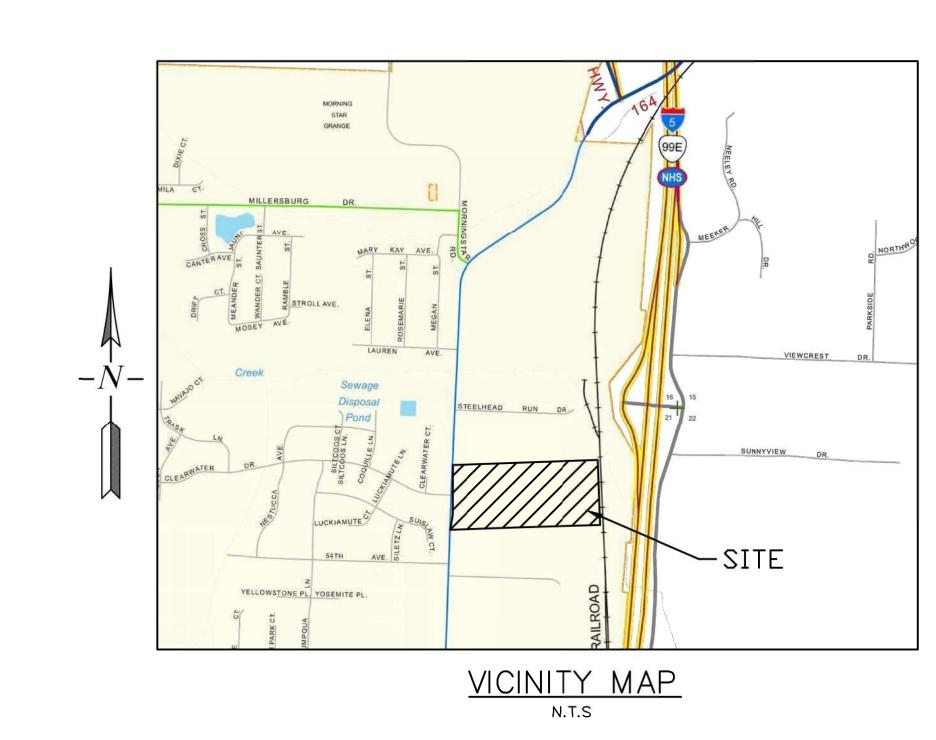


INDEX


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<u>SHEET</u>	<u>DESCRIPTION</u>	
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C5	PRELIMINARY SEWER AND WATER PLAN	
C6	FIRE PROTECTION PLAN	
C7	PRELIMINARY POWER AND FRANCHISE UTILITIES PLAN	
C8	CONSTRUCTION DETAILS	
	CONSTRUCTION DETAILS	

DEQ - 1200-C PERMIT (LISTED FOR REFERENCE ONLY)

ESC1	EROSION & SEDIMENT CONTROL COVER SHEET
ESC2	EARLY CONSTRUCTION EROSION & SEDIMENT CONTROL PLAN
ESC3	LATE CONSTRUCTION EROSION& SEDIMENT CONTROL PLAN
ESC4	EROSION & SEDIMENT CONTROL DETAILS

MOST RECENT REVISION TO THIS SET OF PLANS:

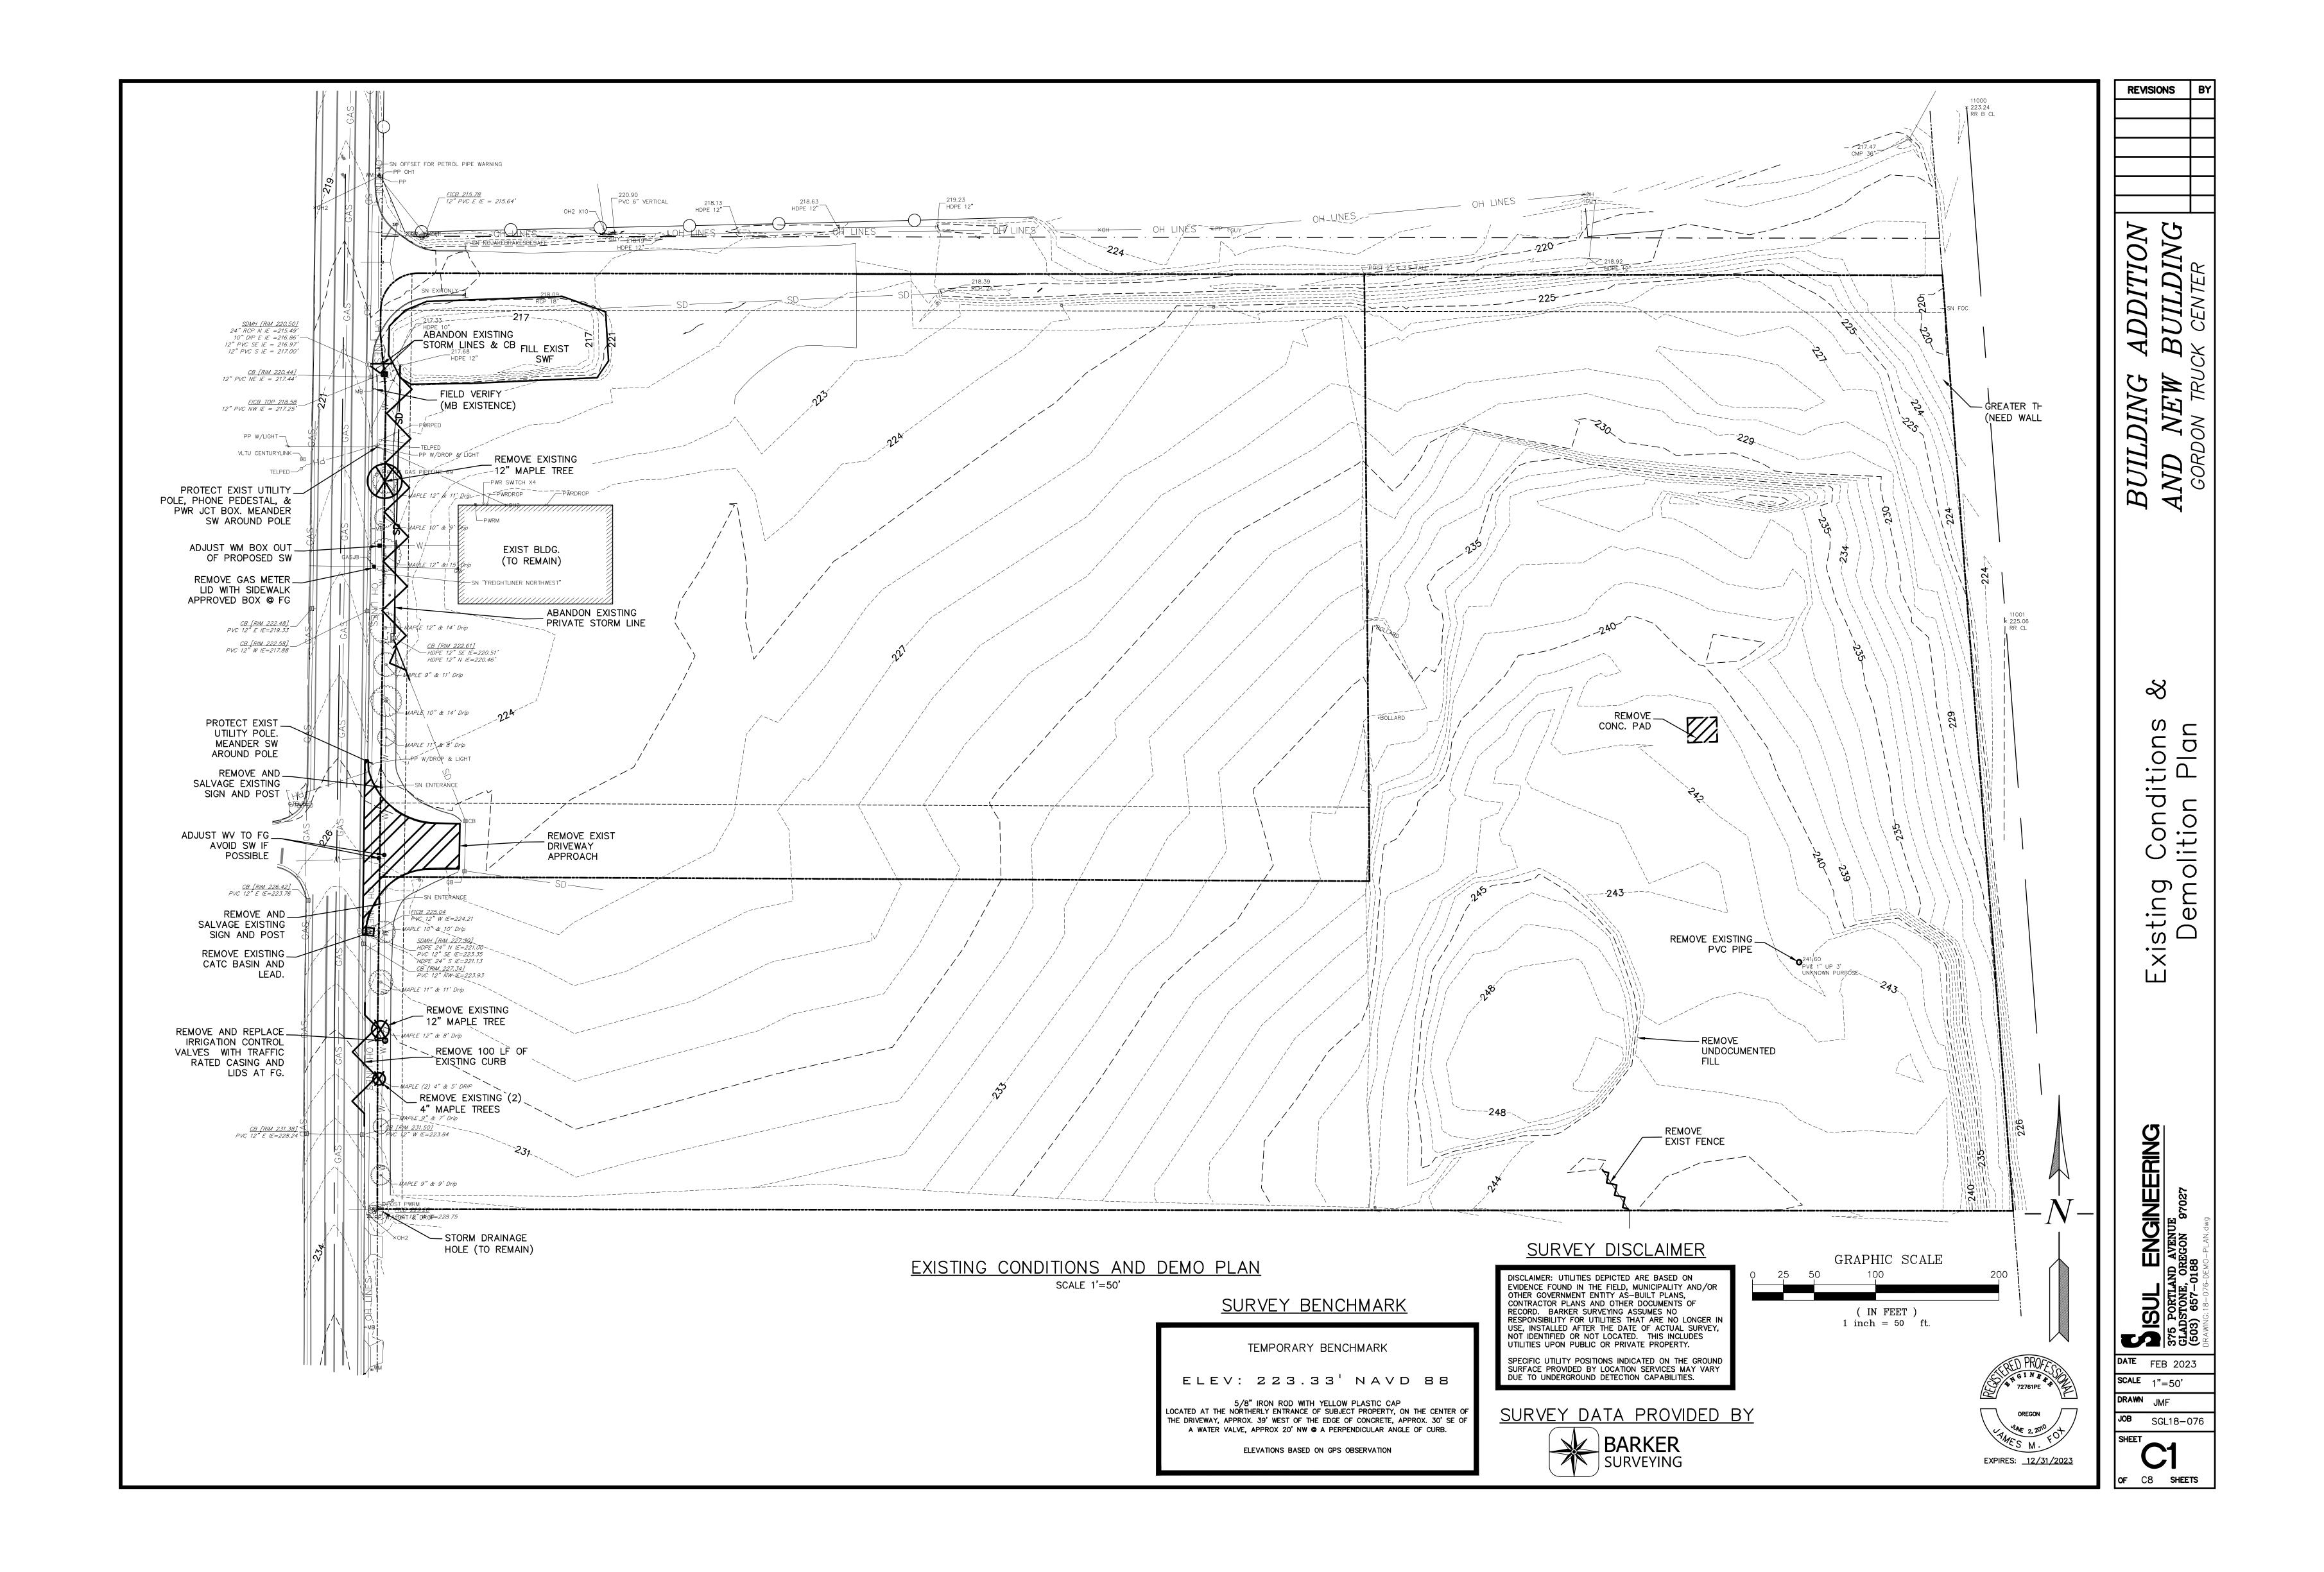

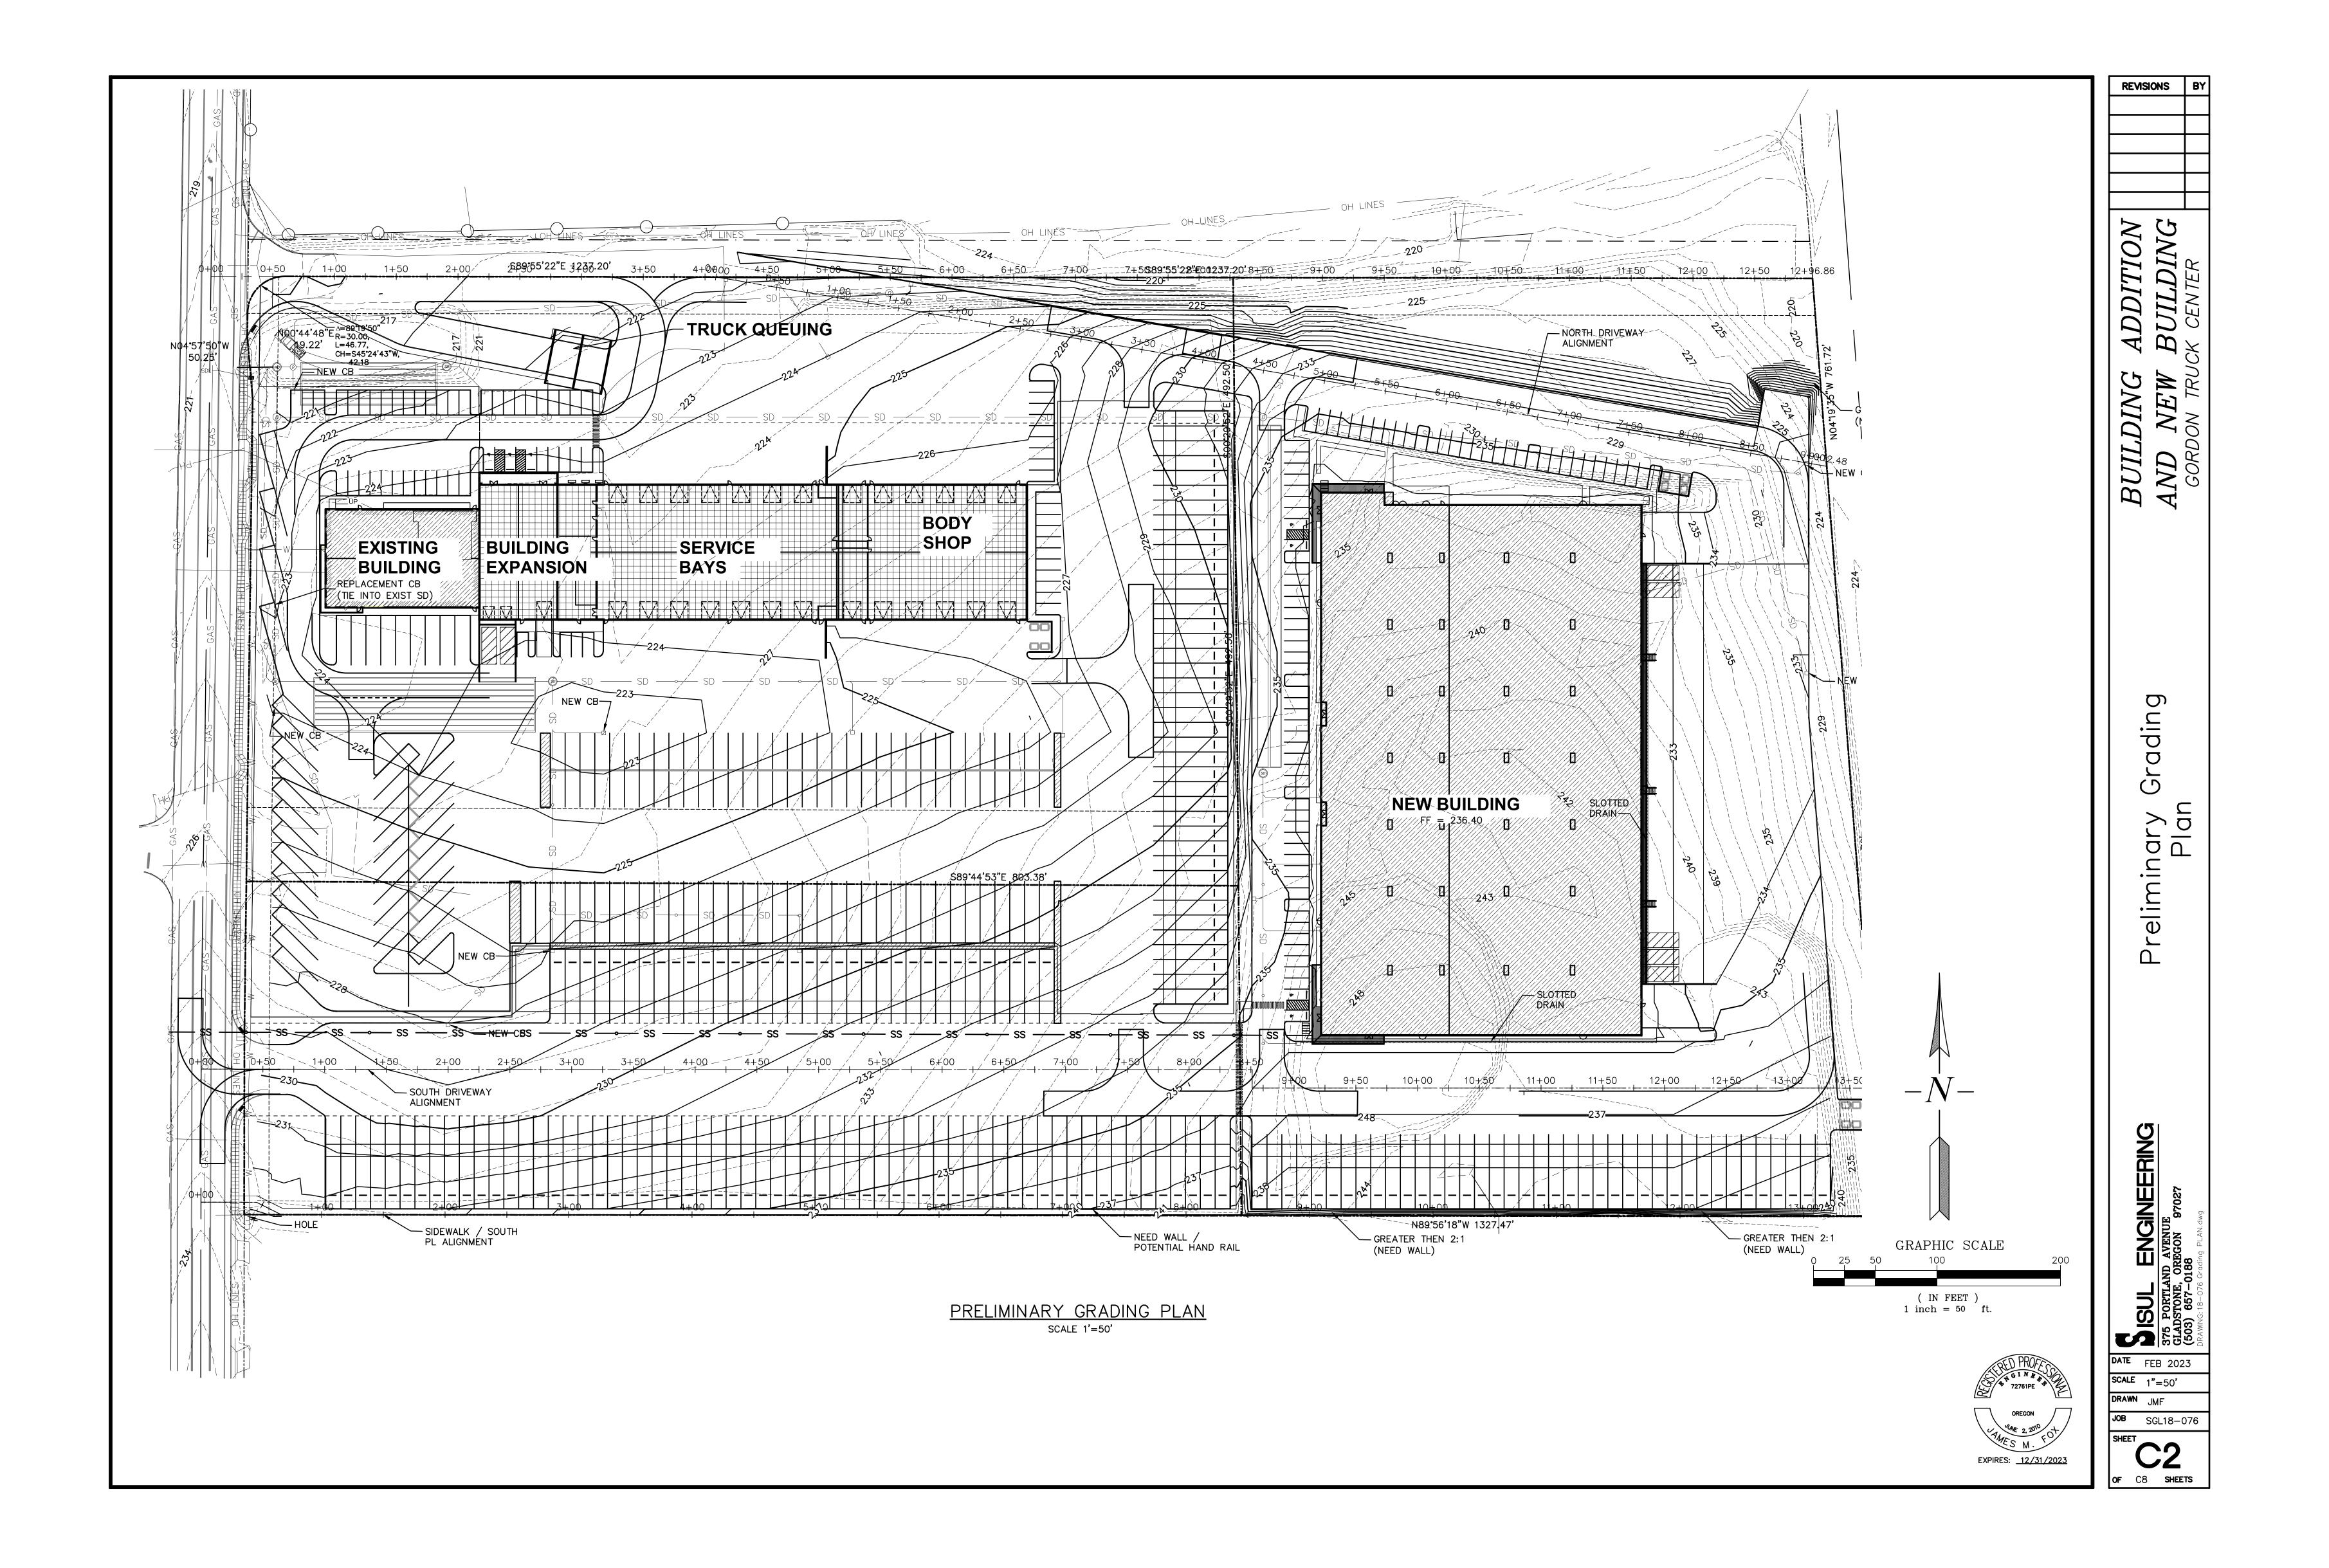

NORTH ACCESS

HORIZONTAL SCALE: 1"=50' VERTICAL SCALE: 1"=7'




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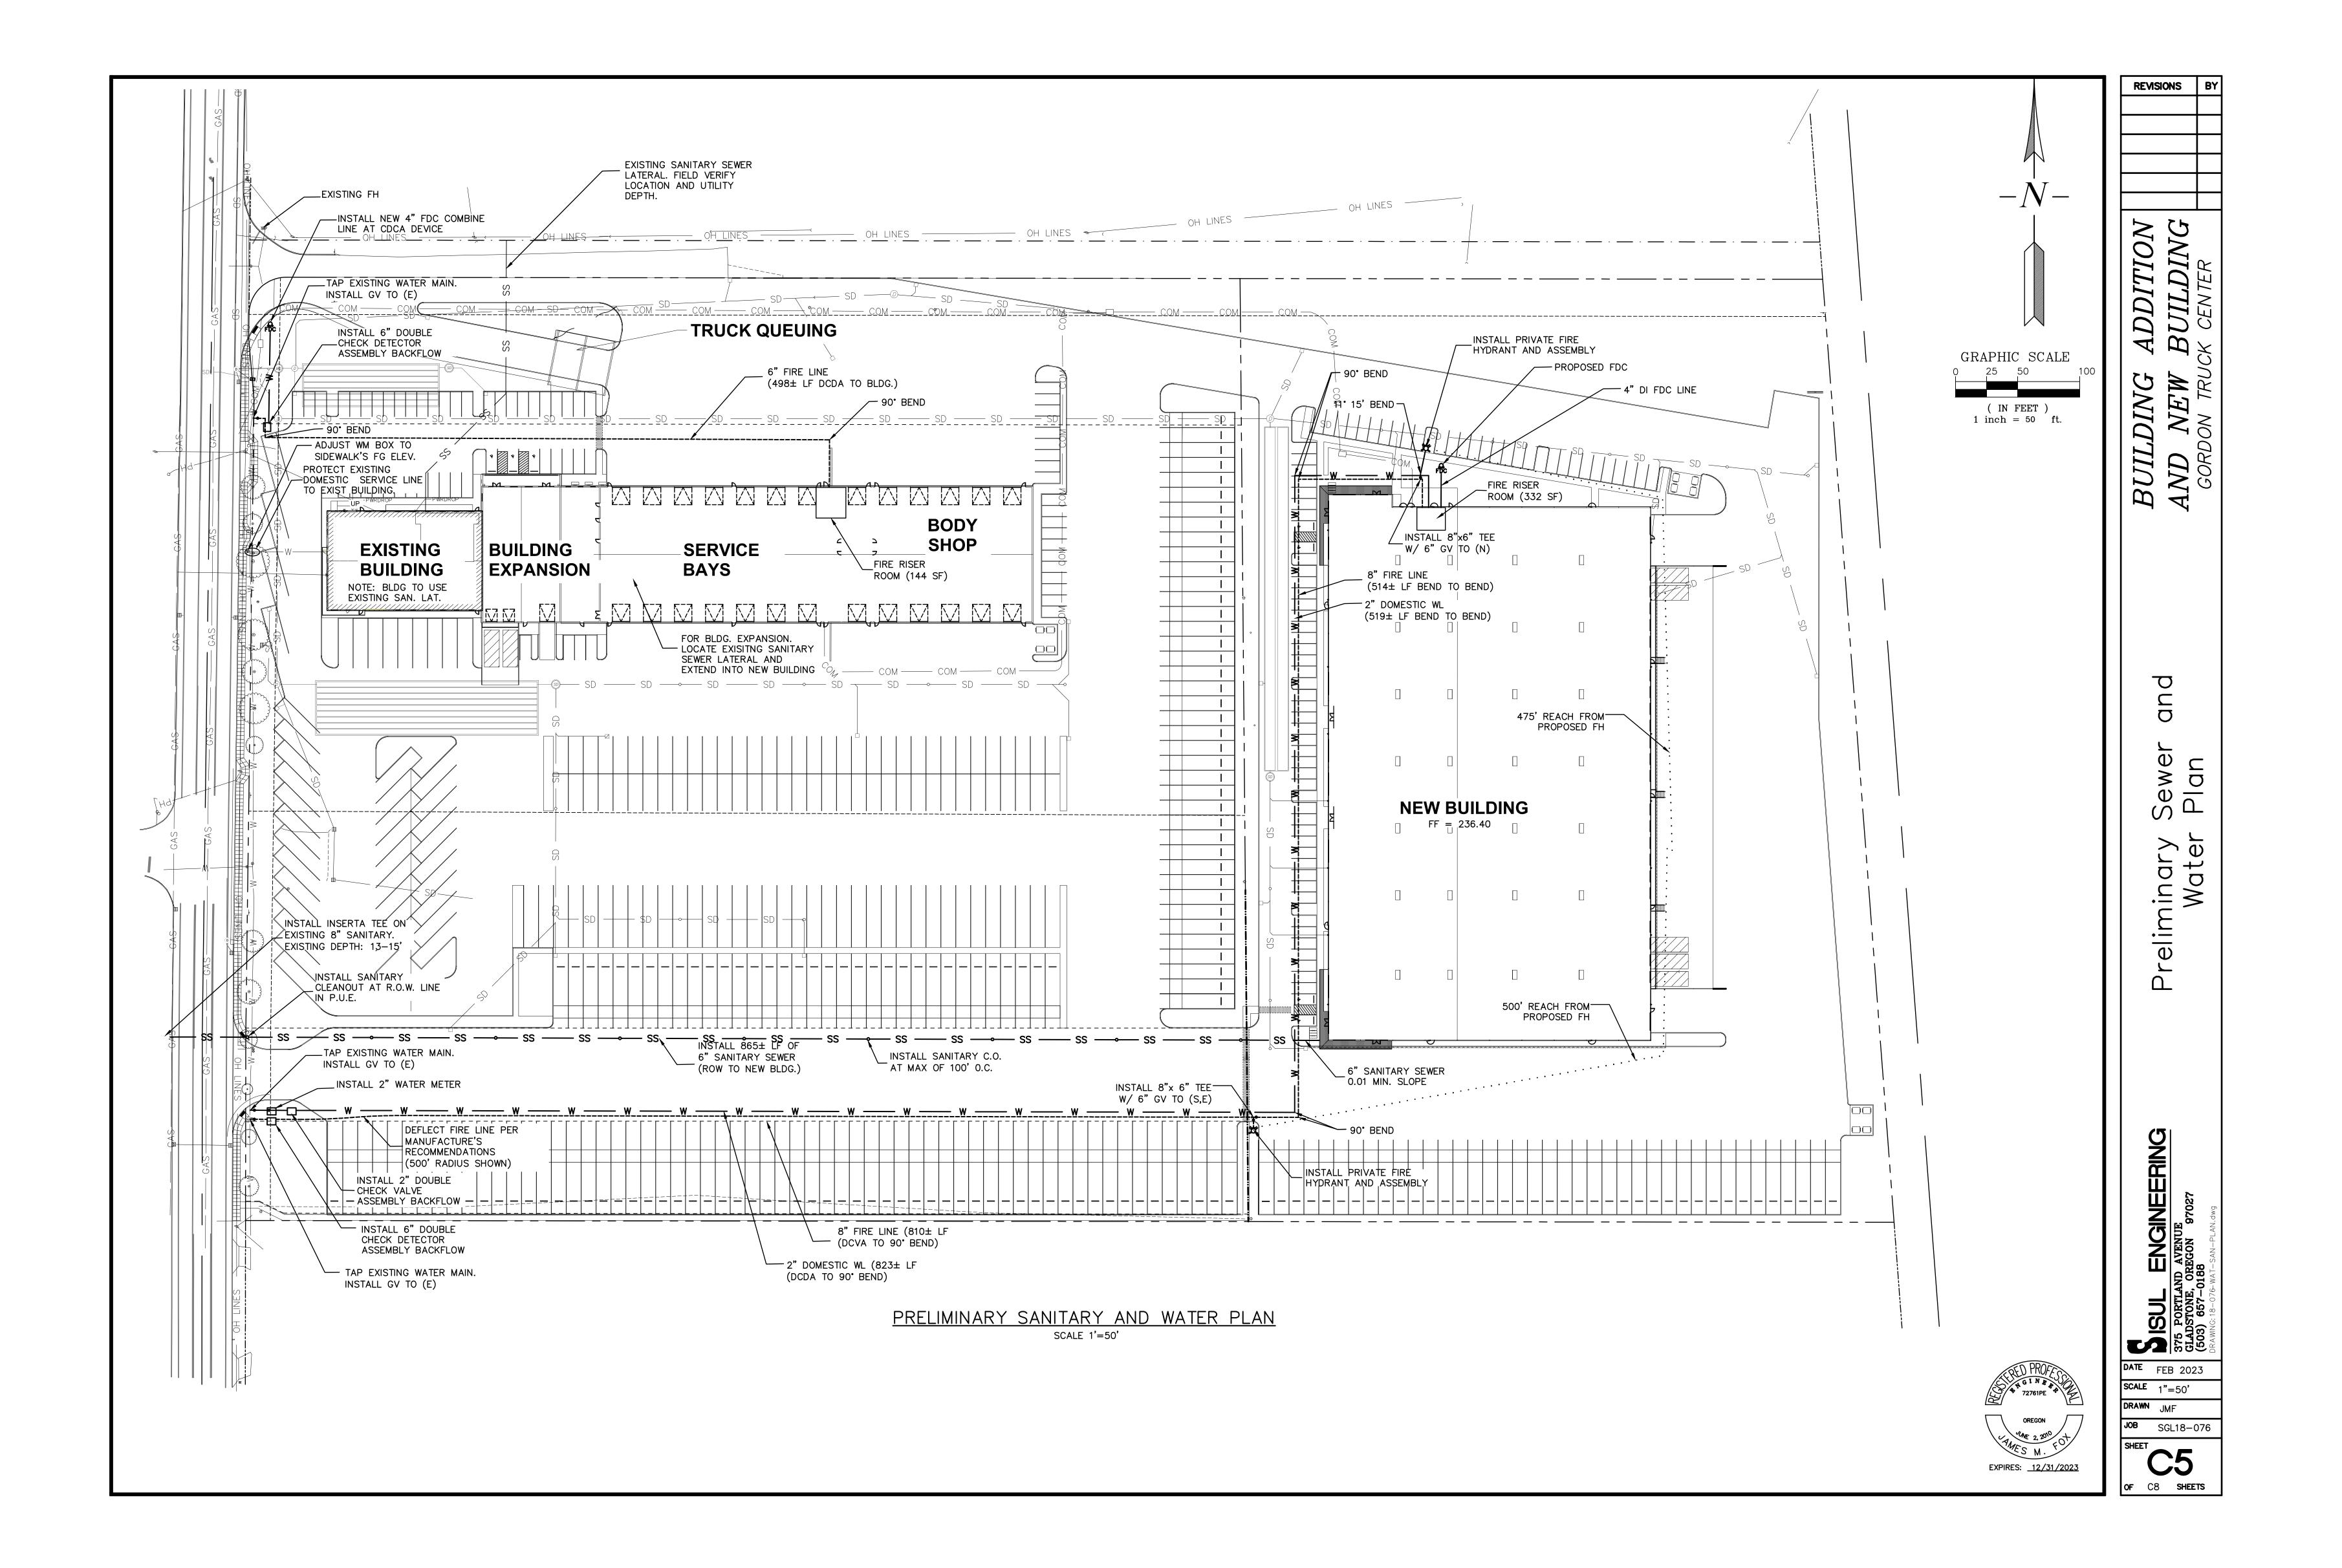
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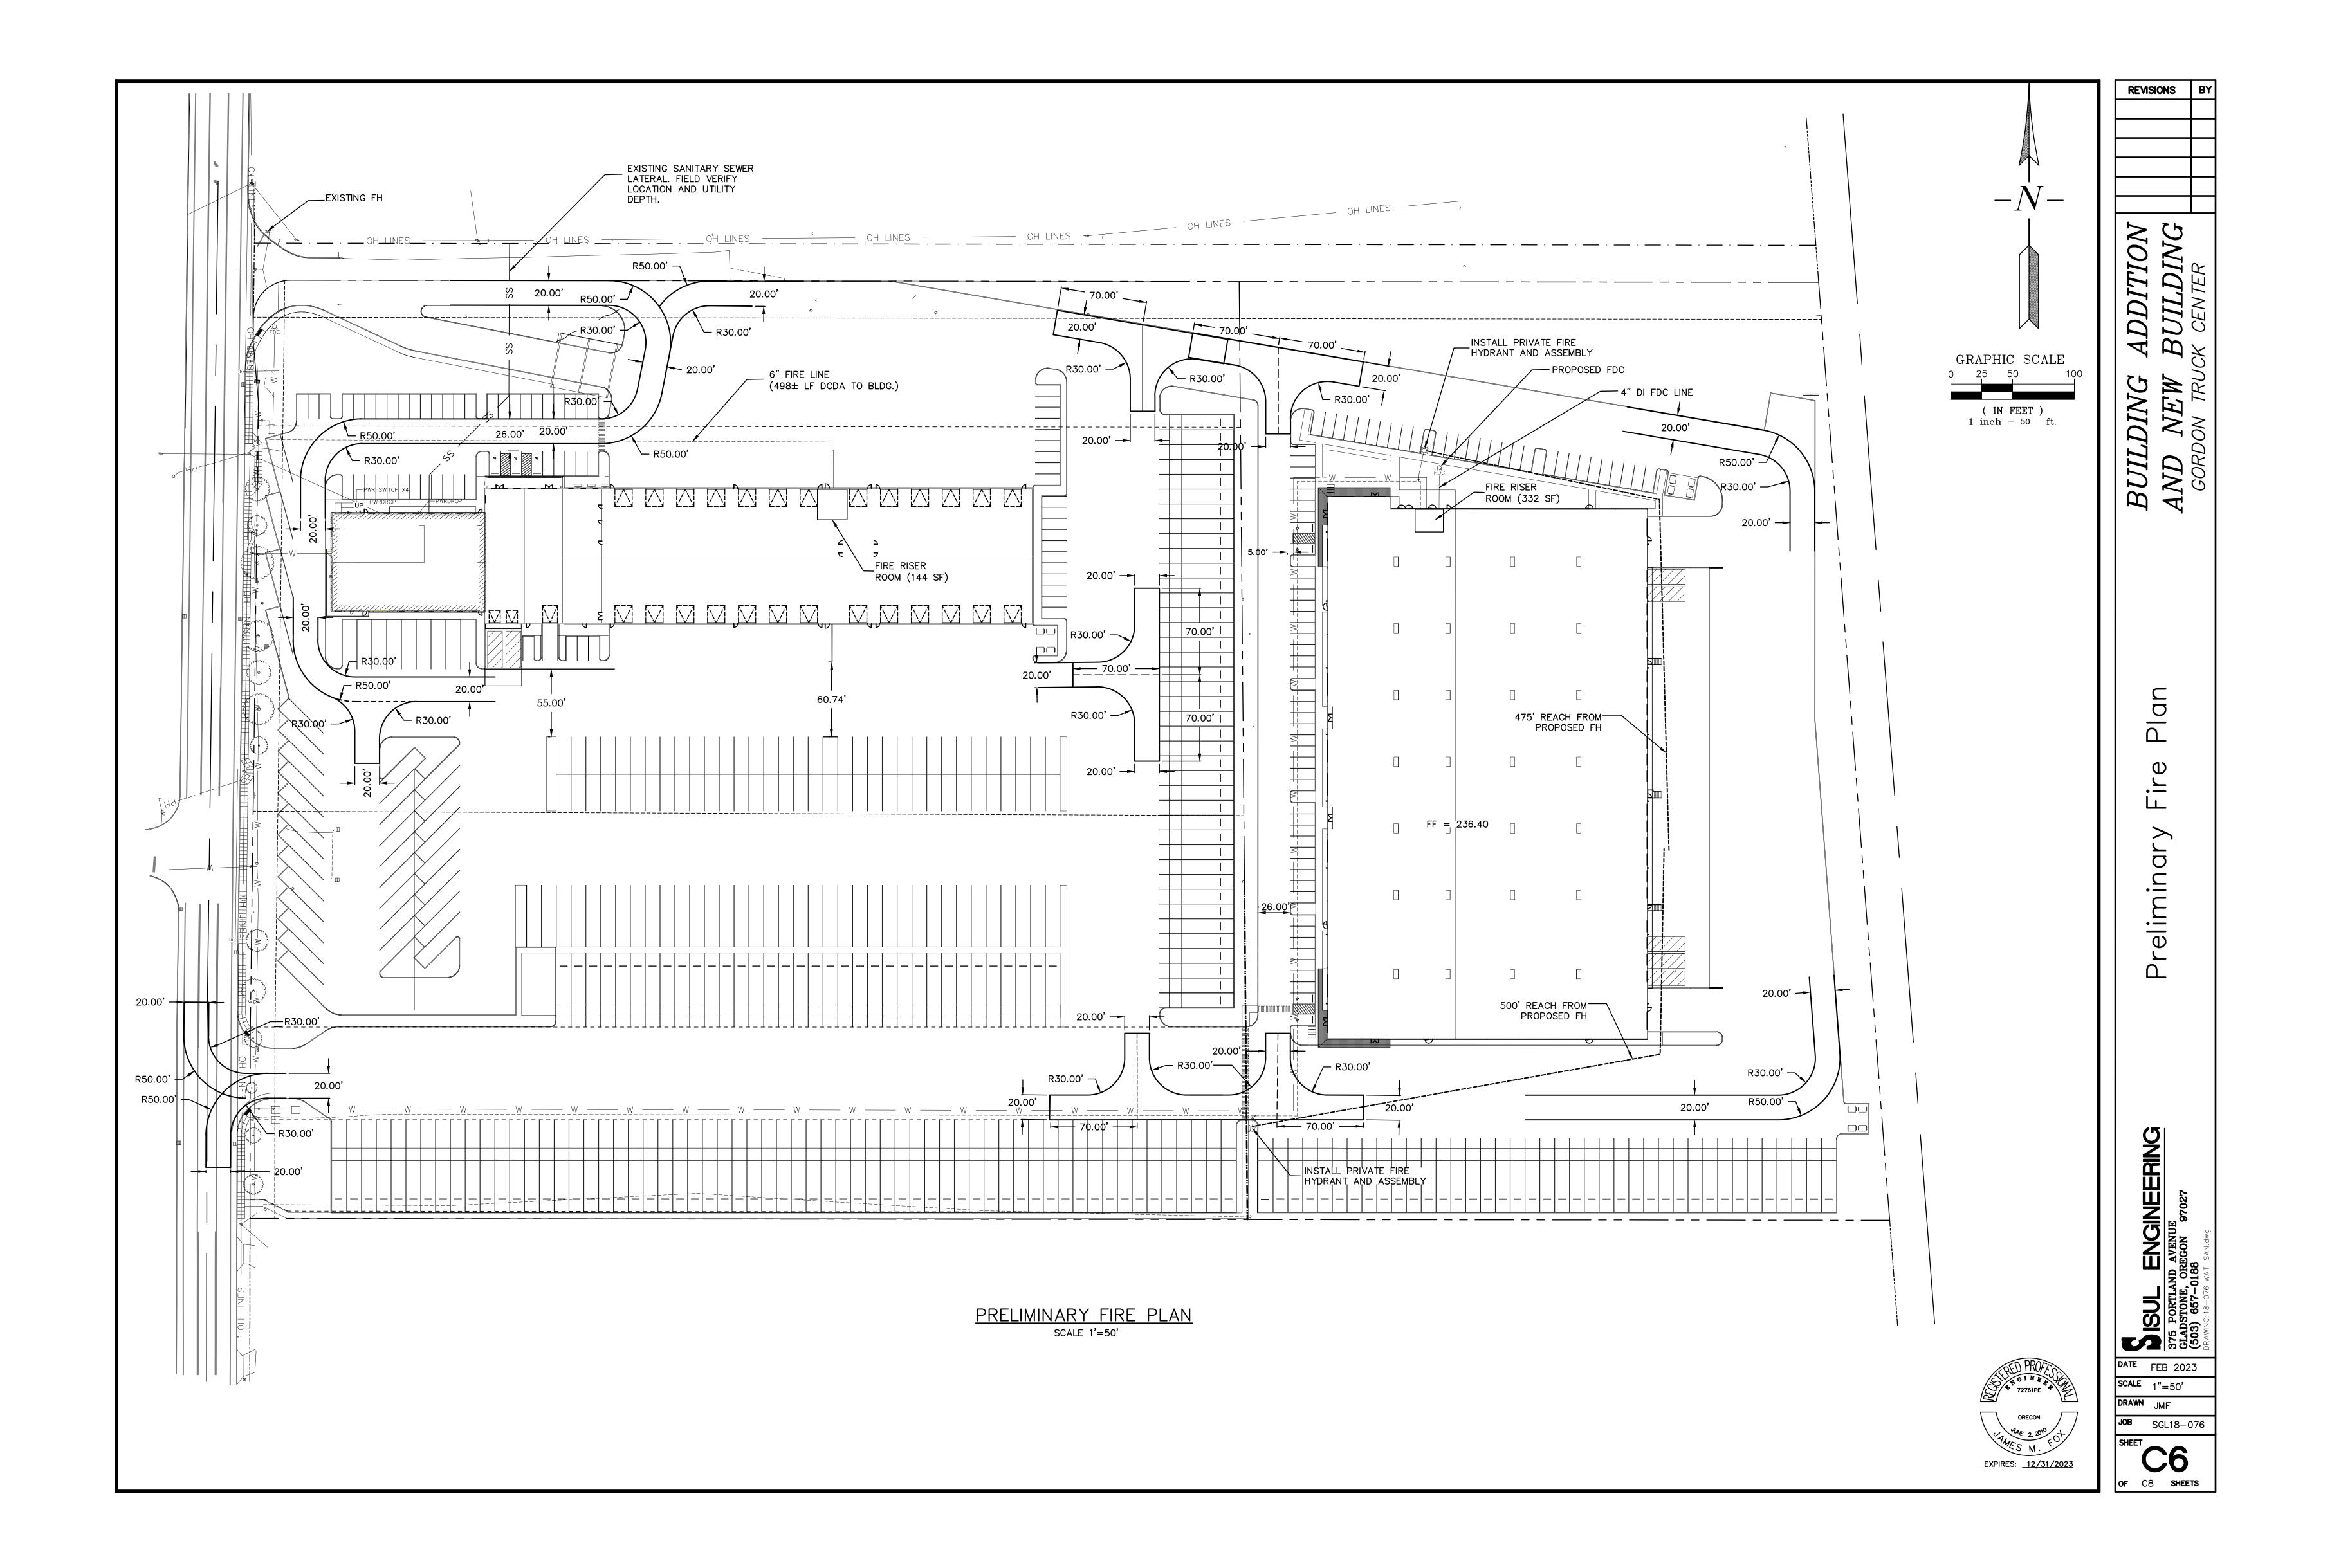
375 PORTLAND AVENUE
GLADSTONE, OREGON 97027
(503) 657-0188


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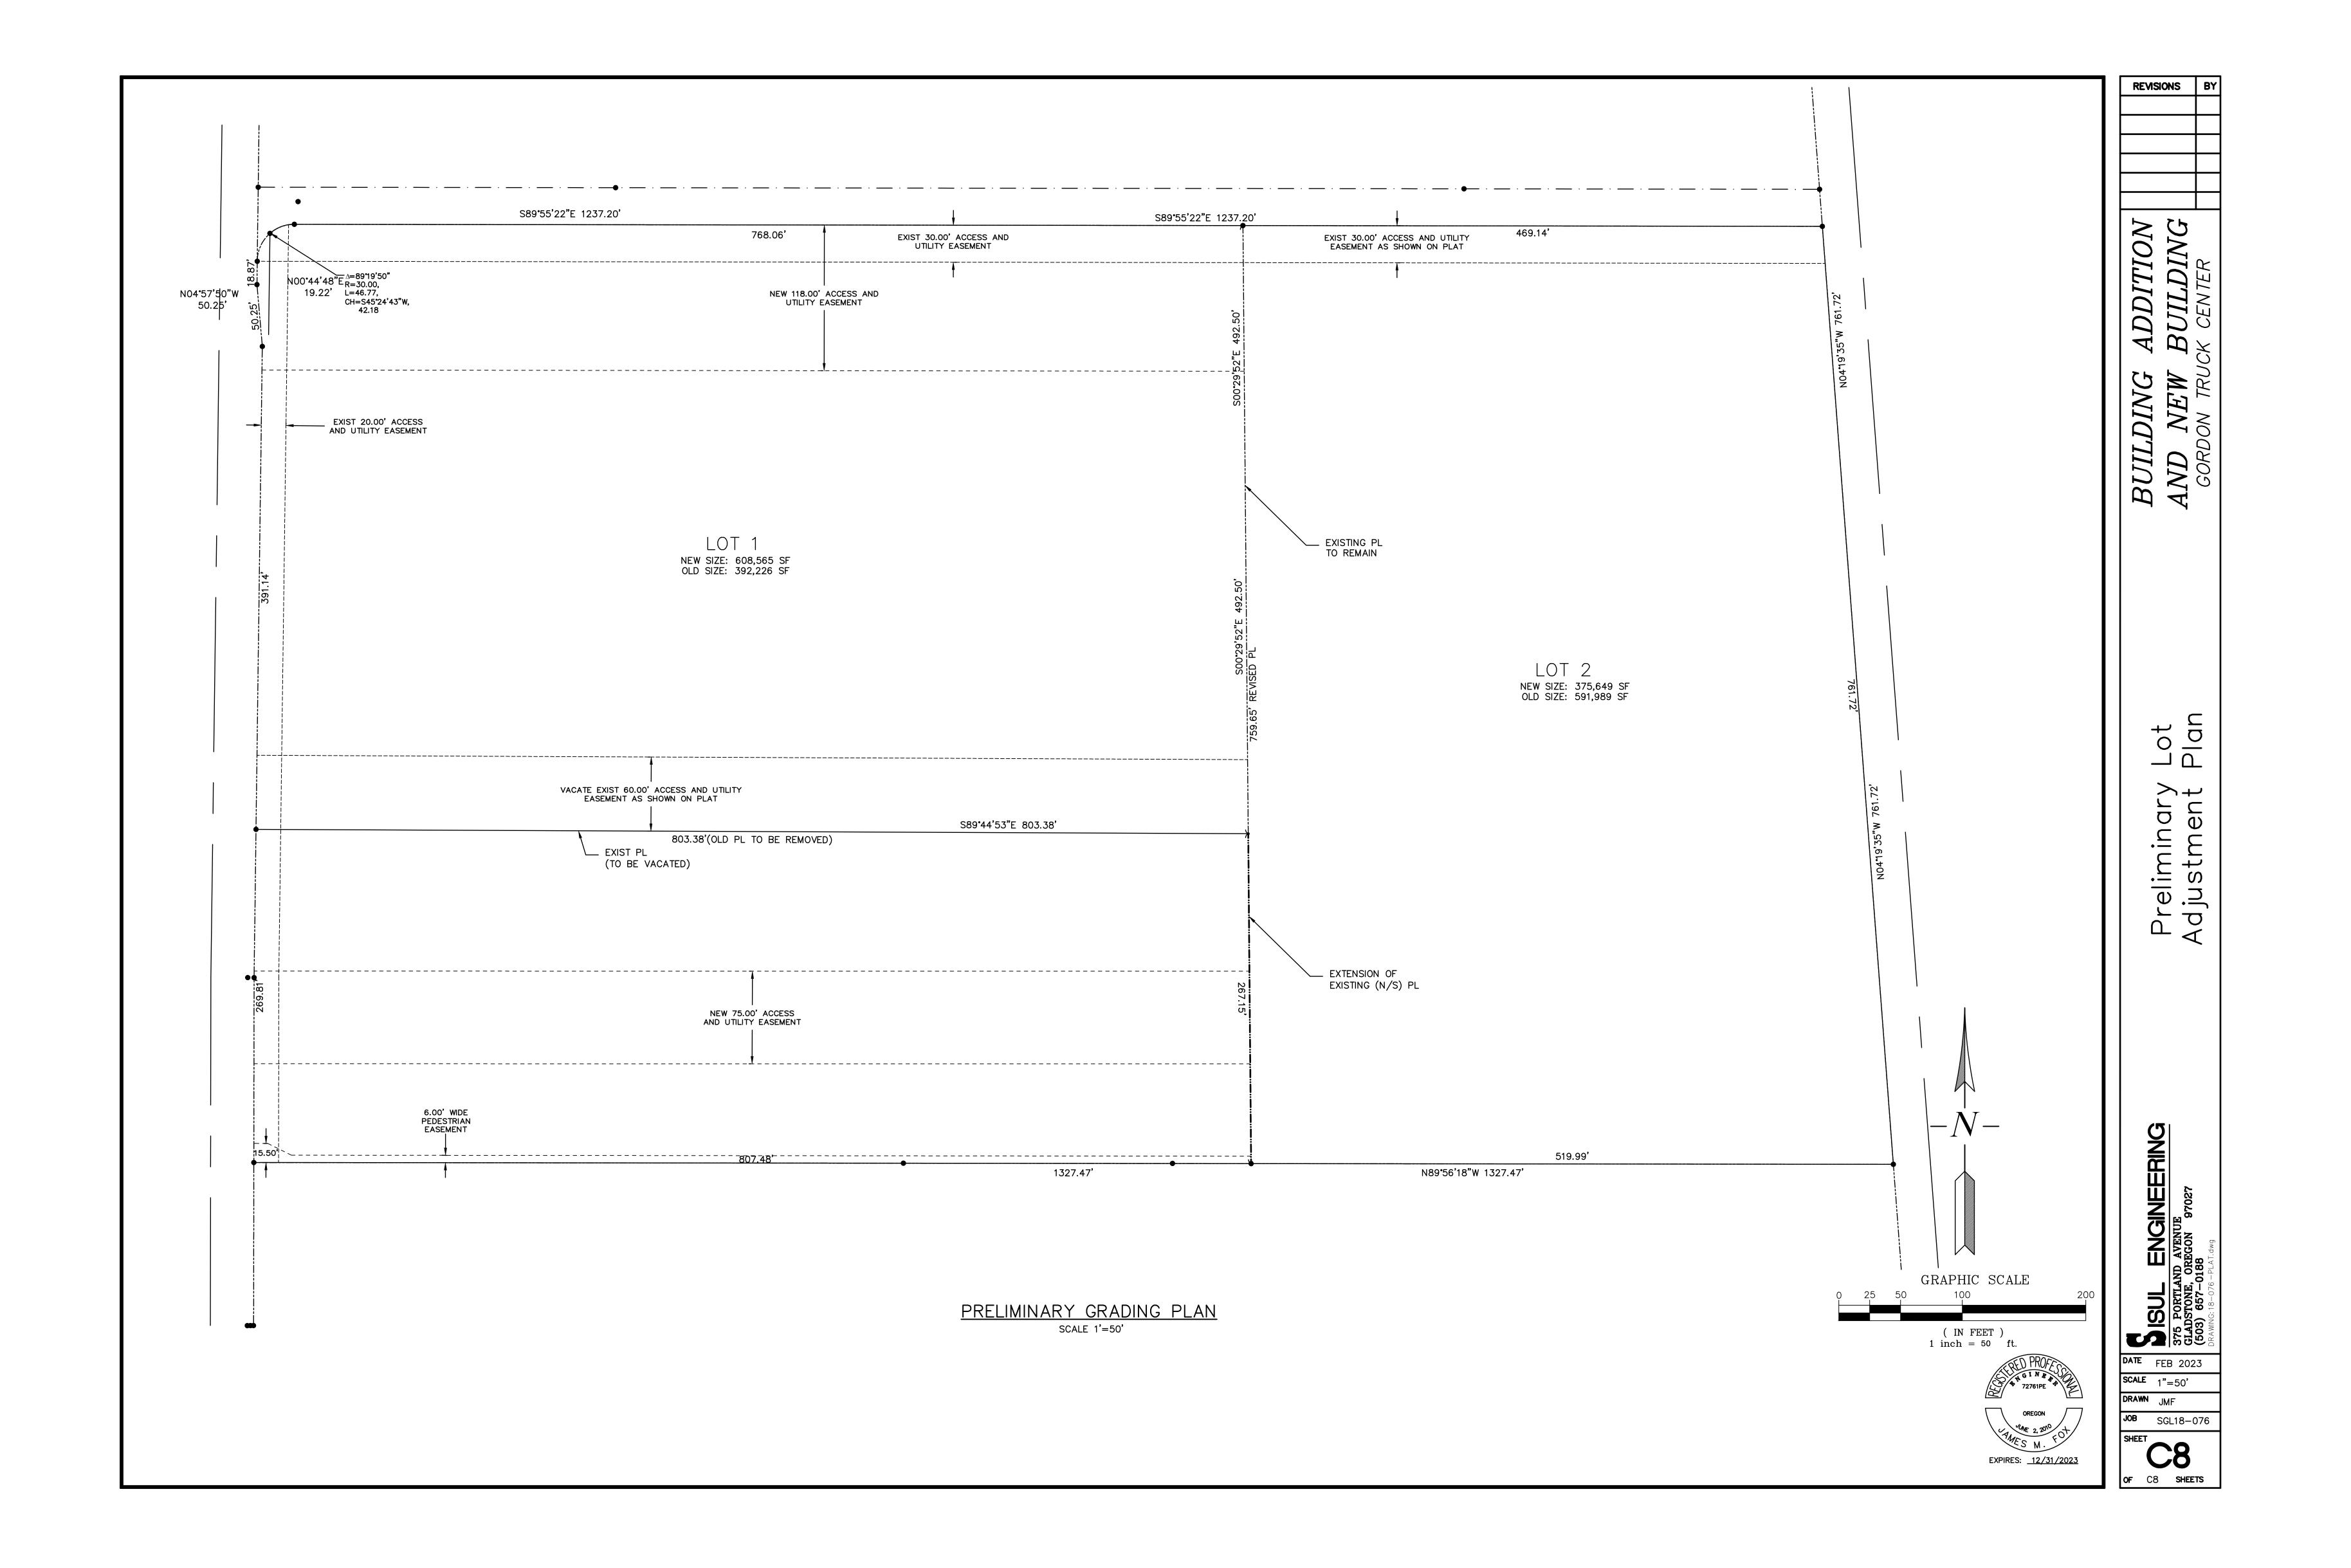
DATE FEB 2023 SCALE 1"=50'
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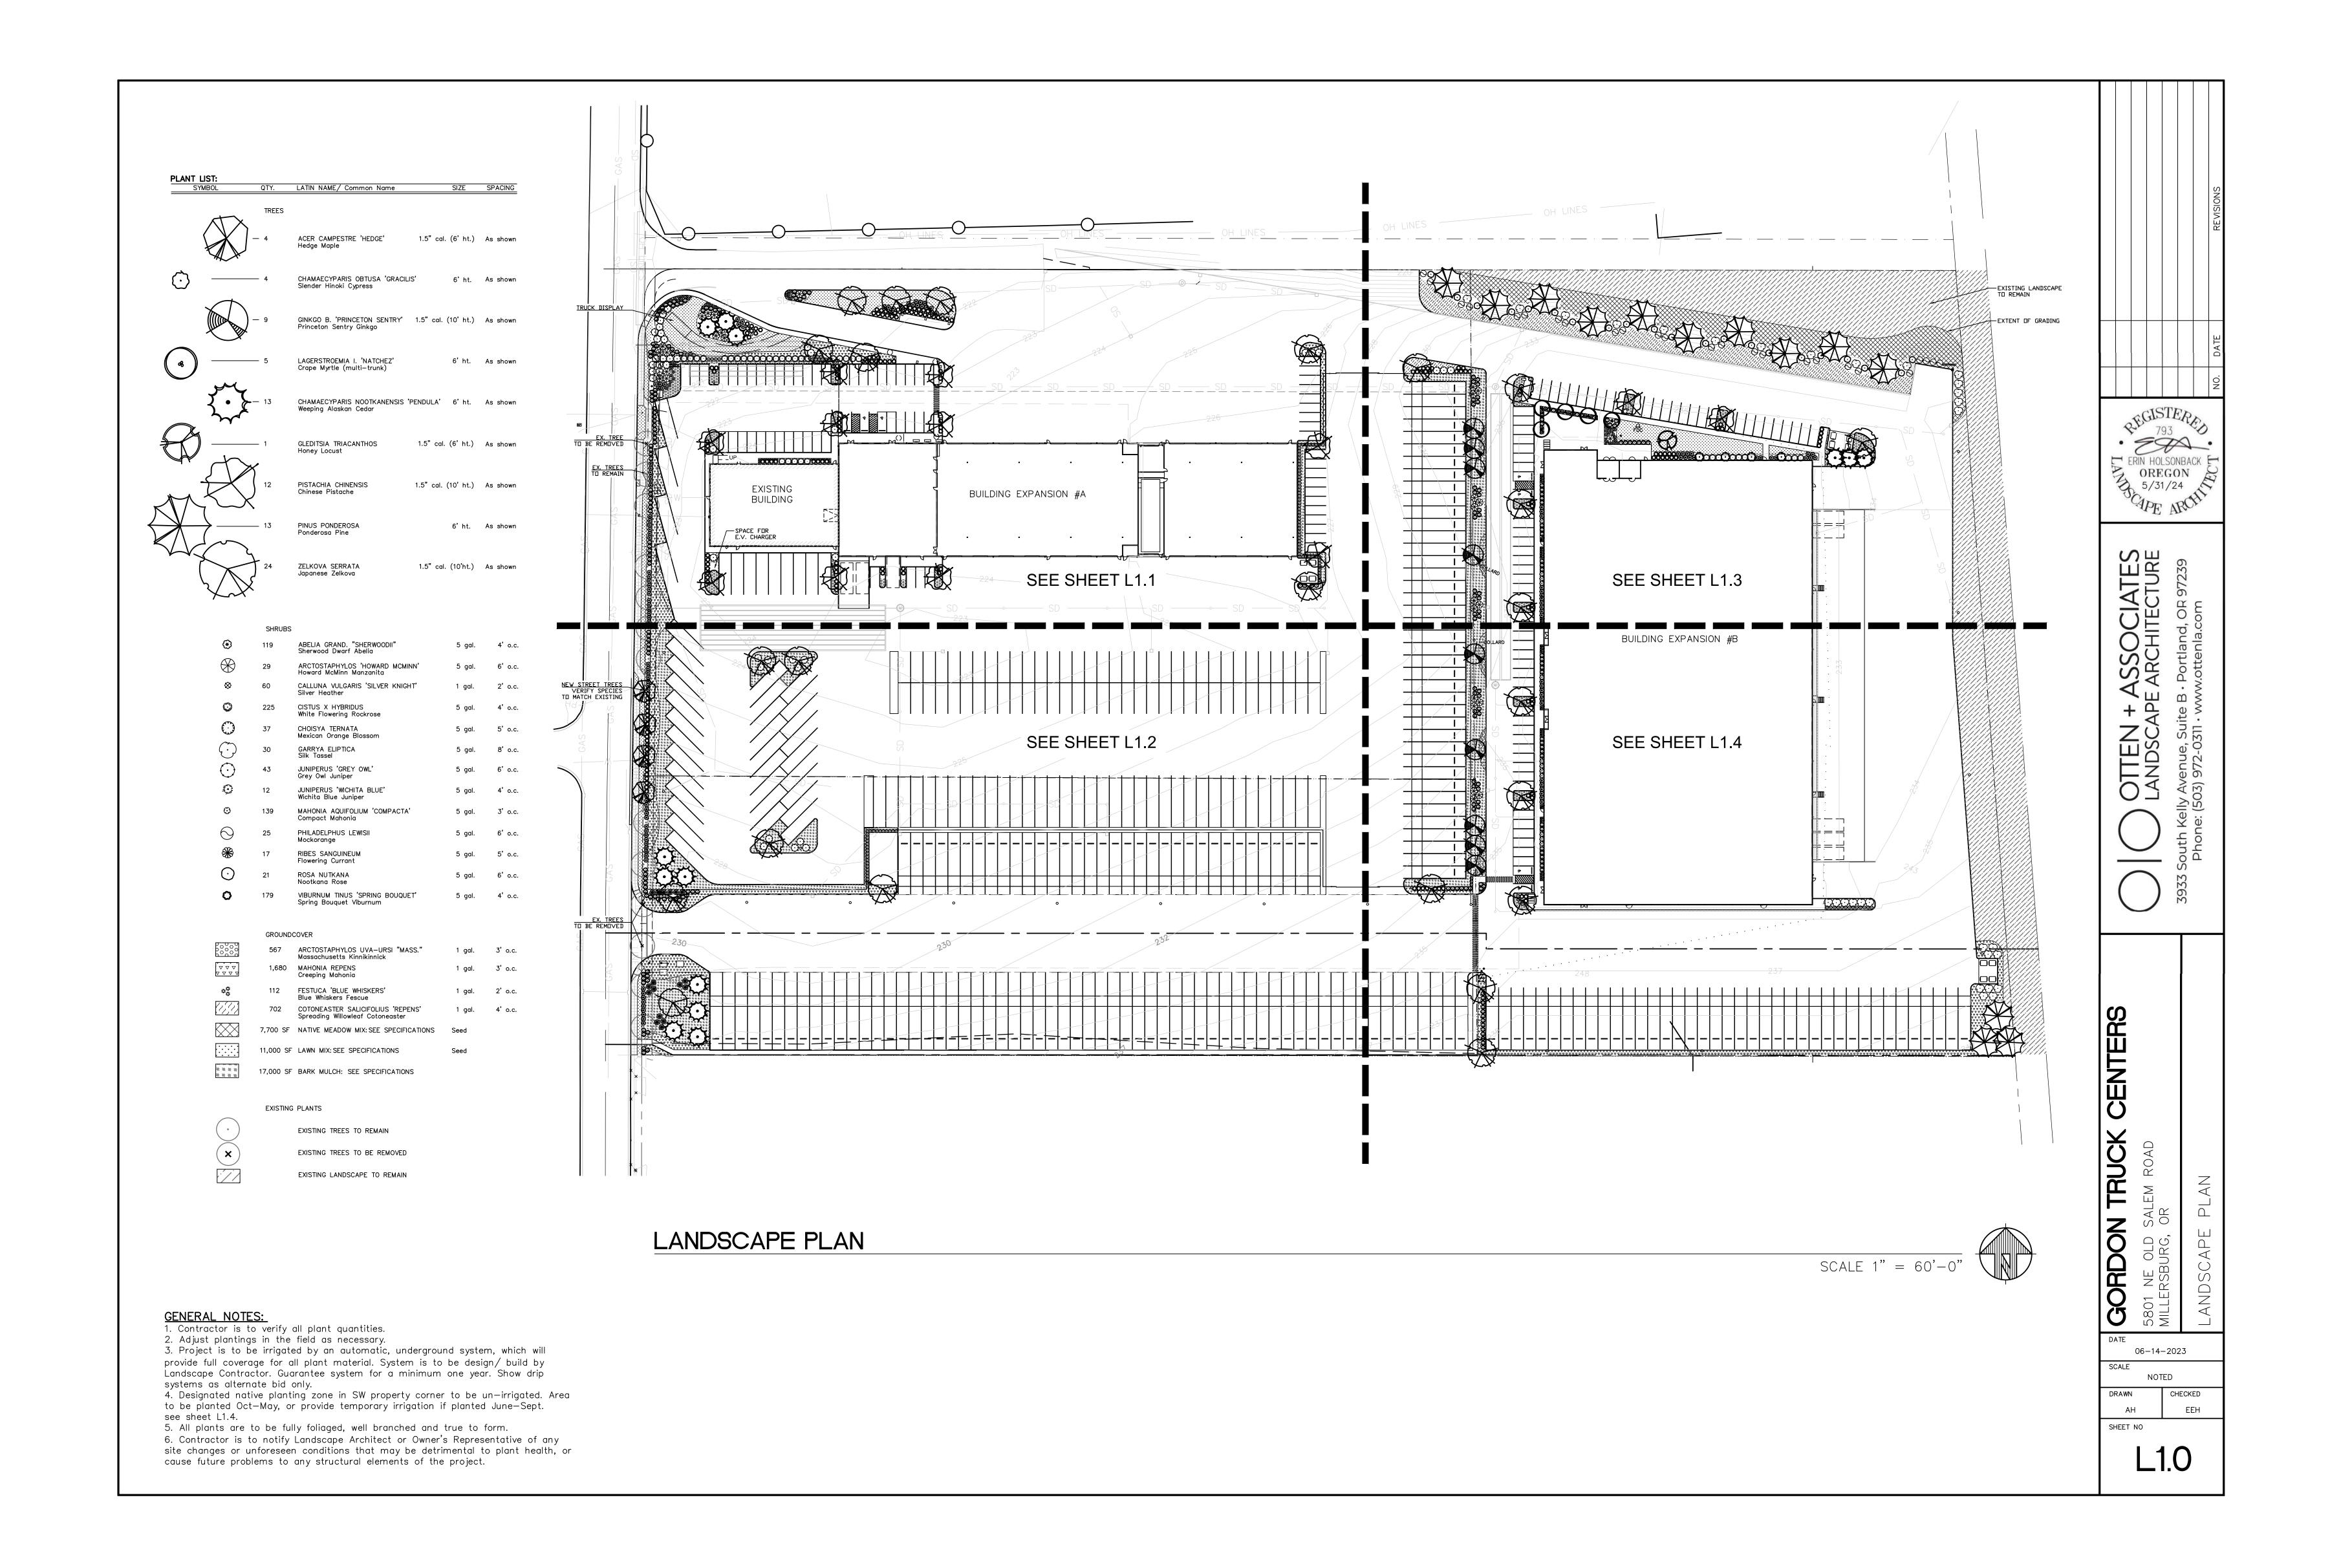











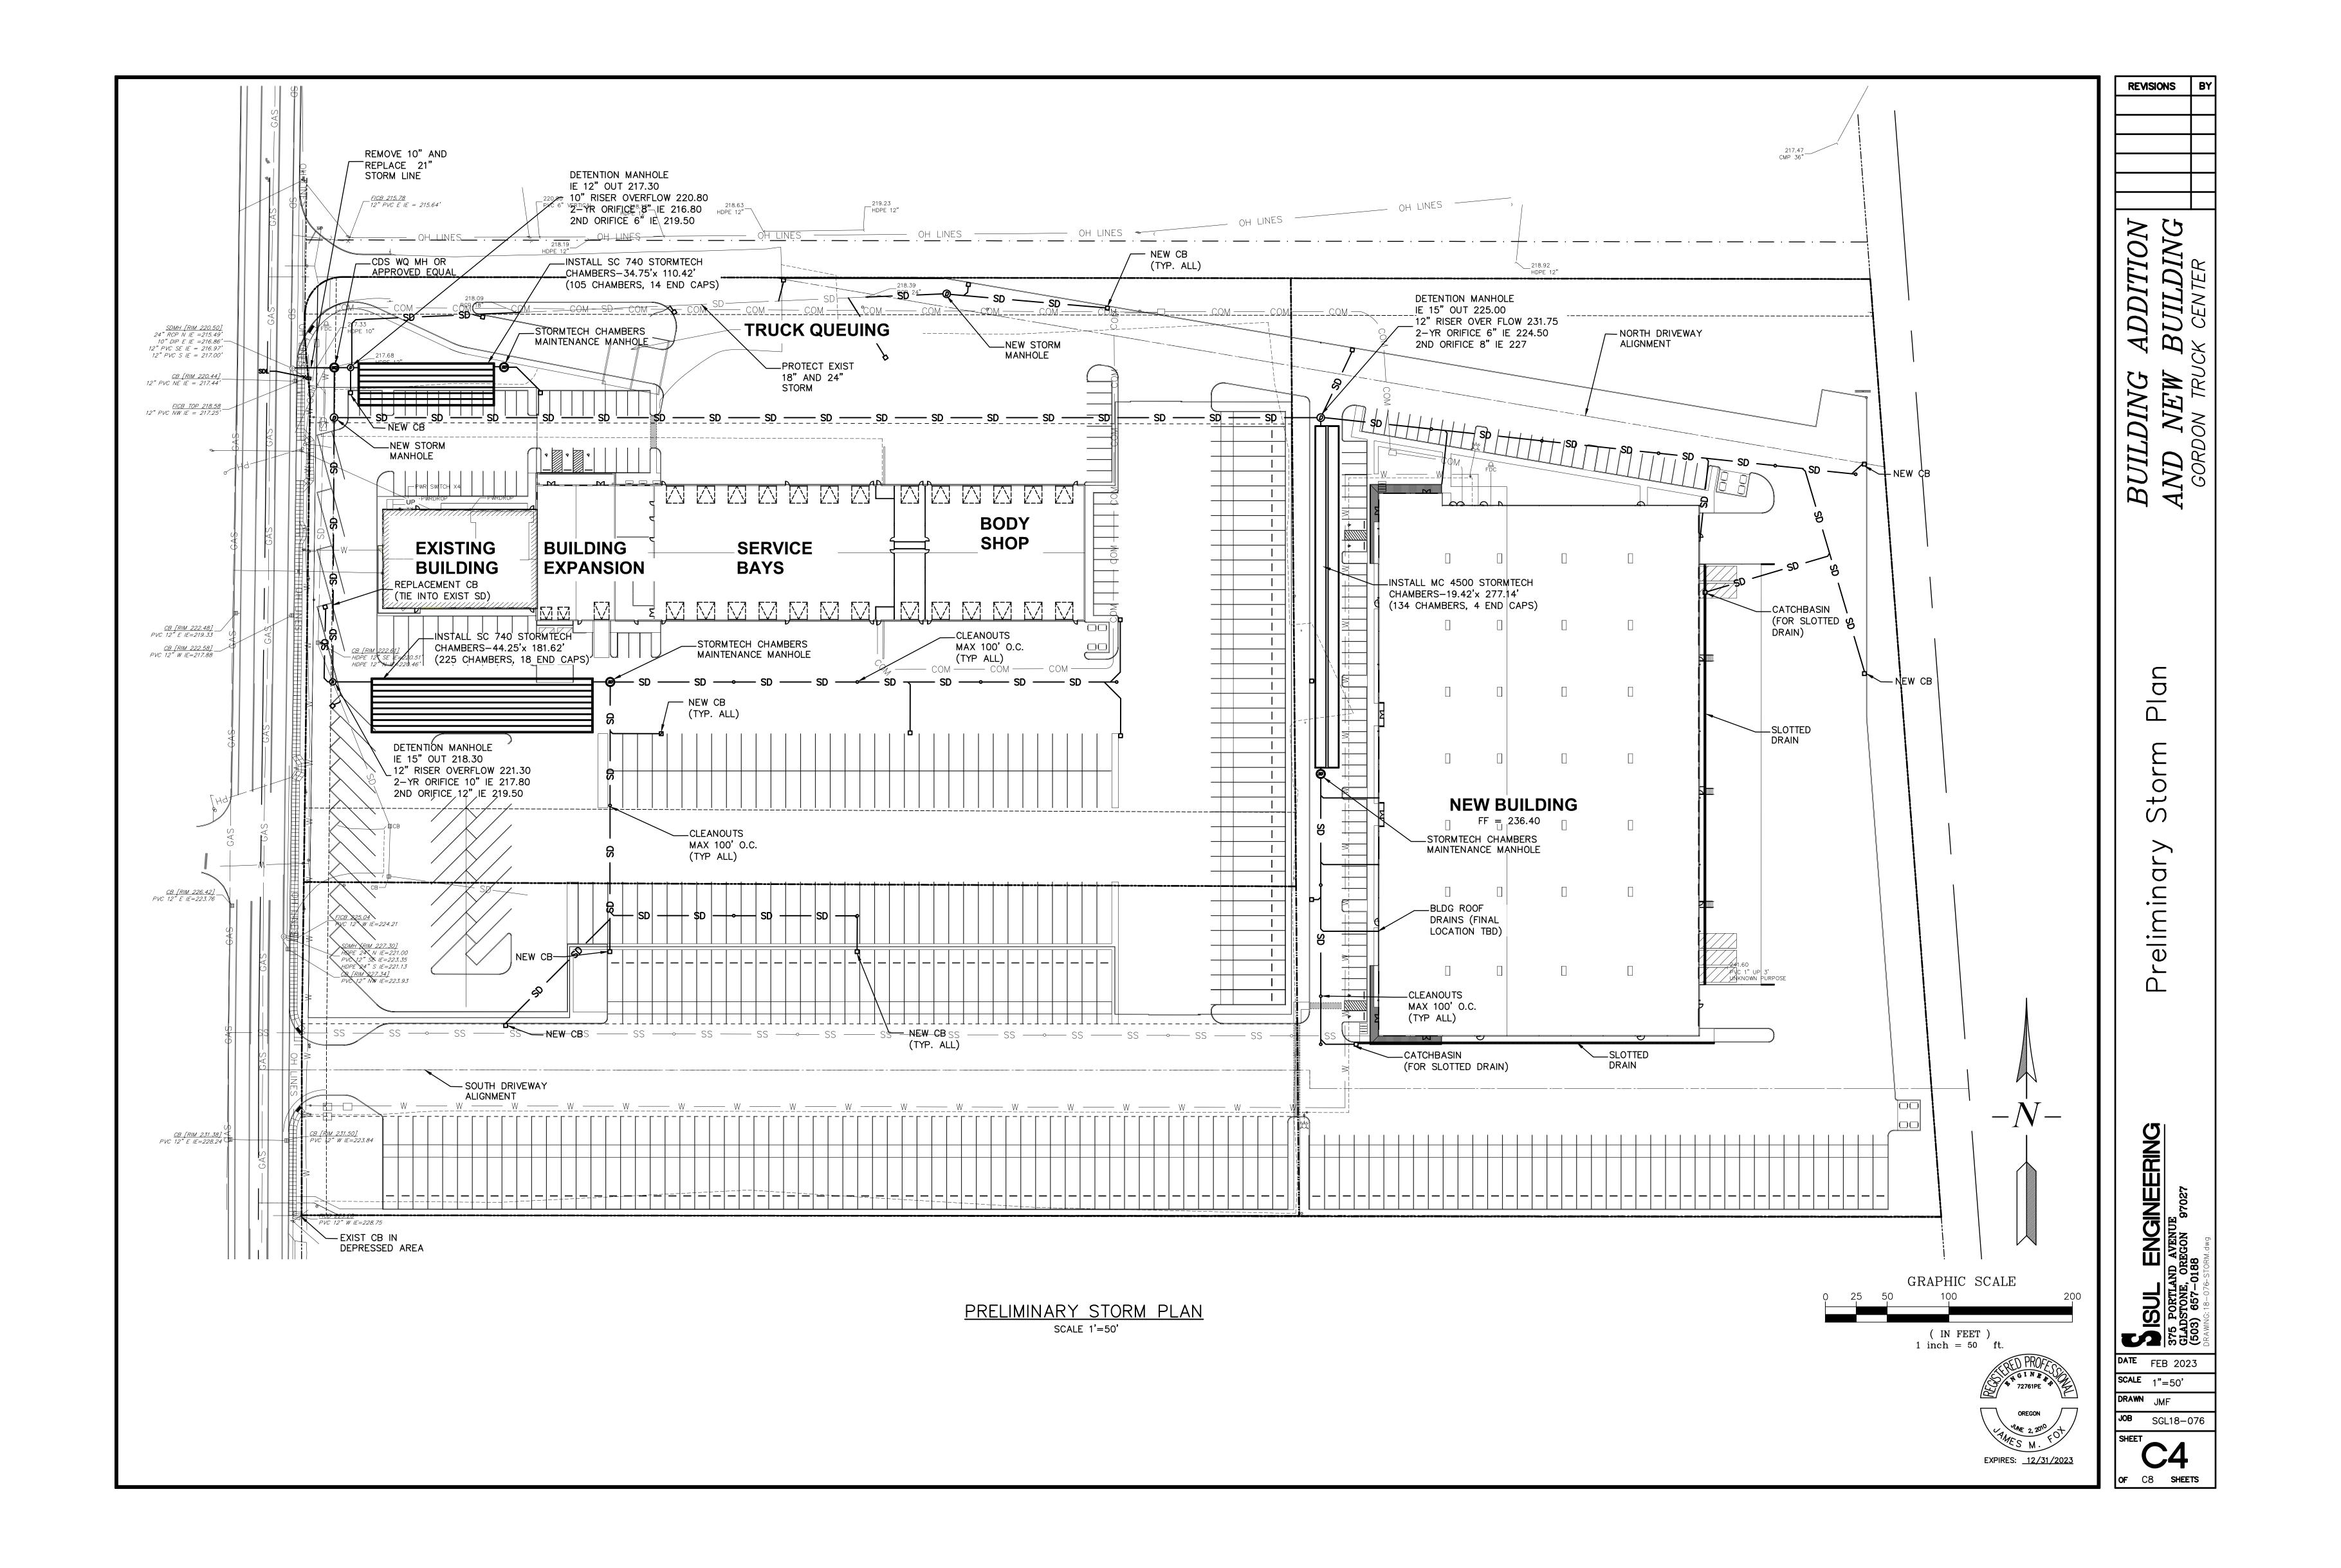


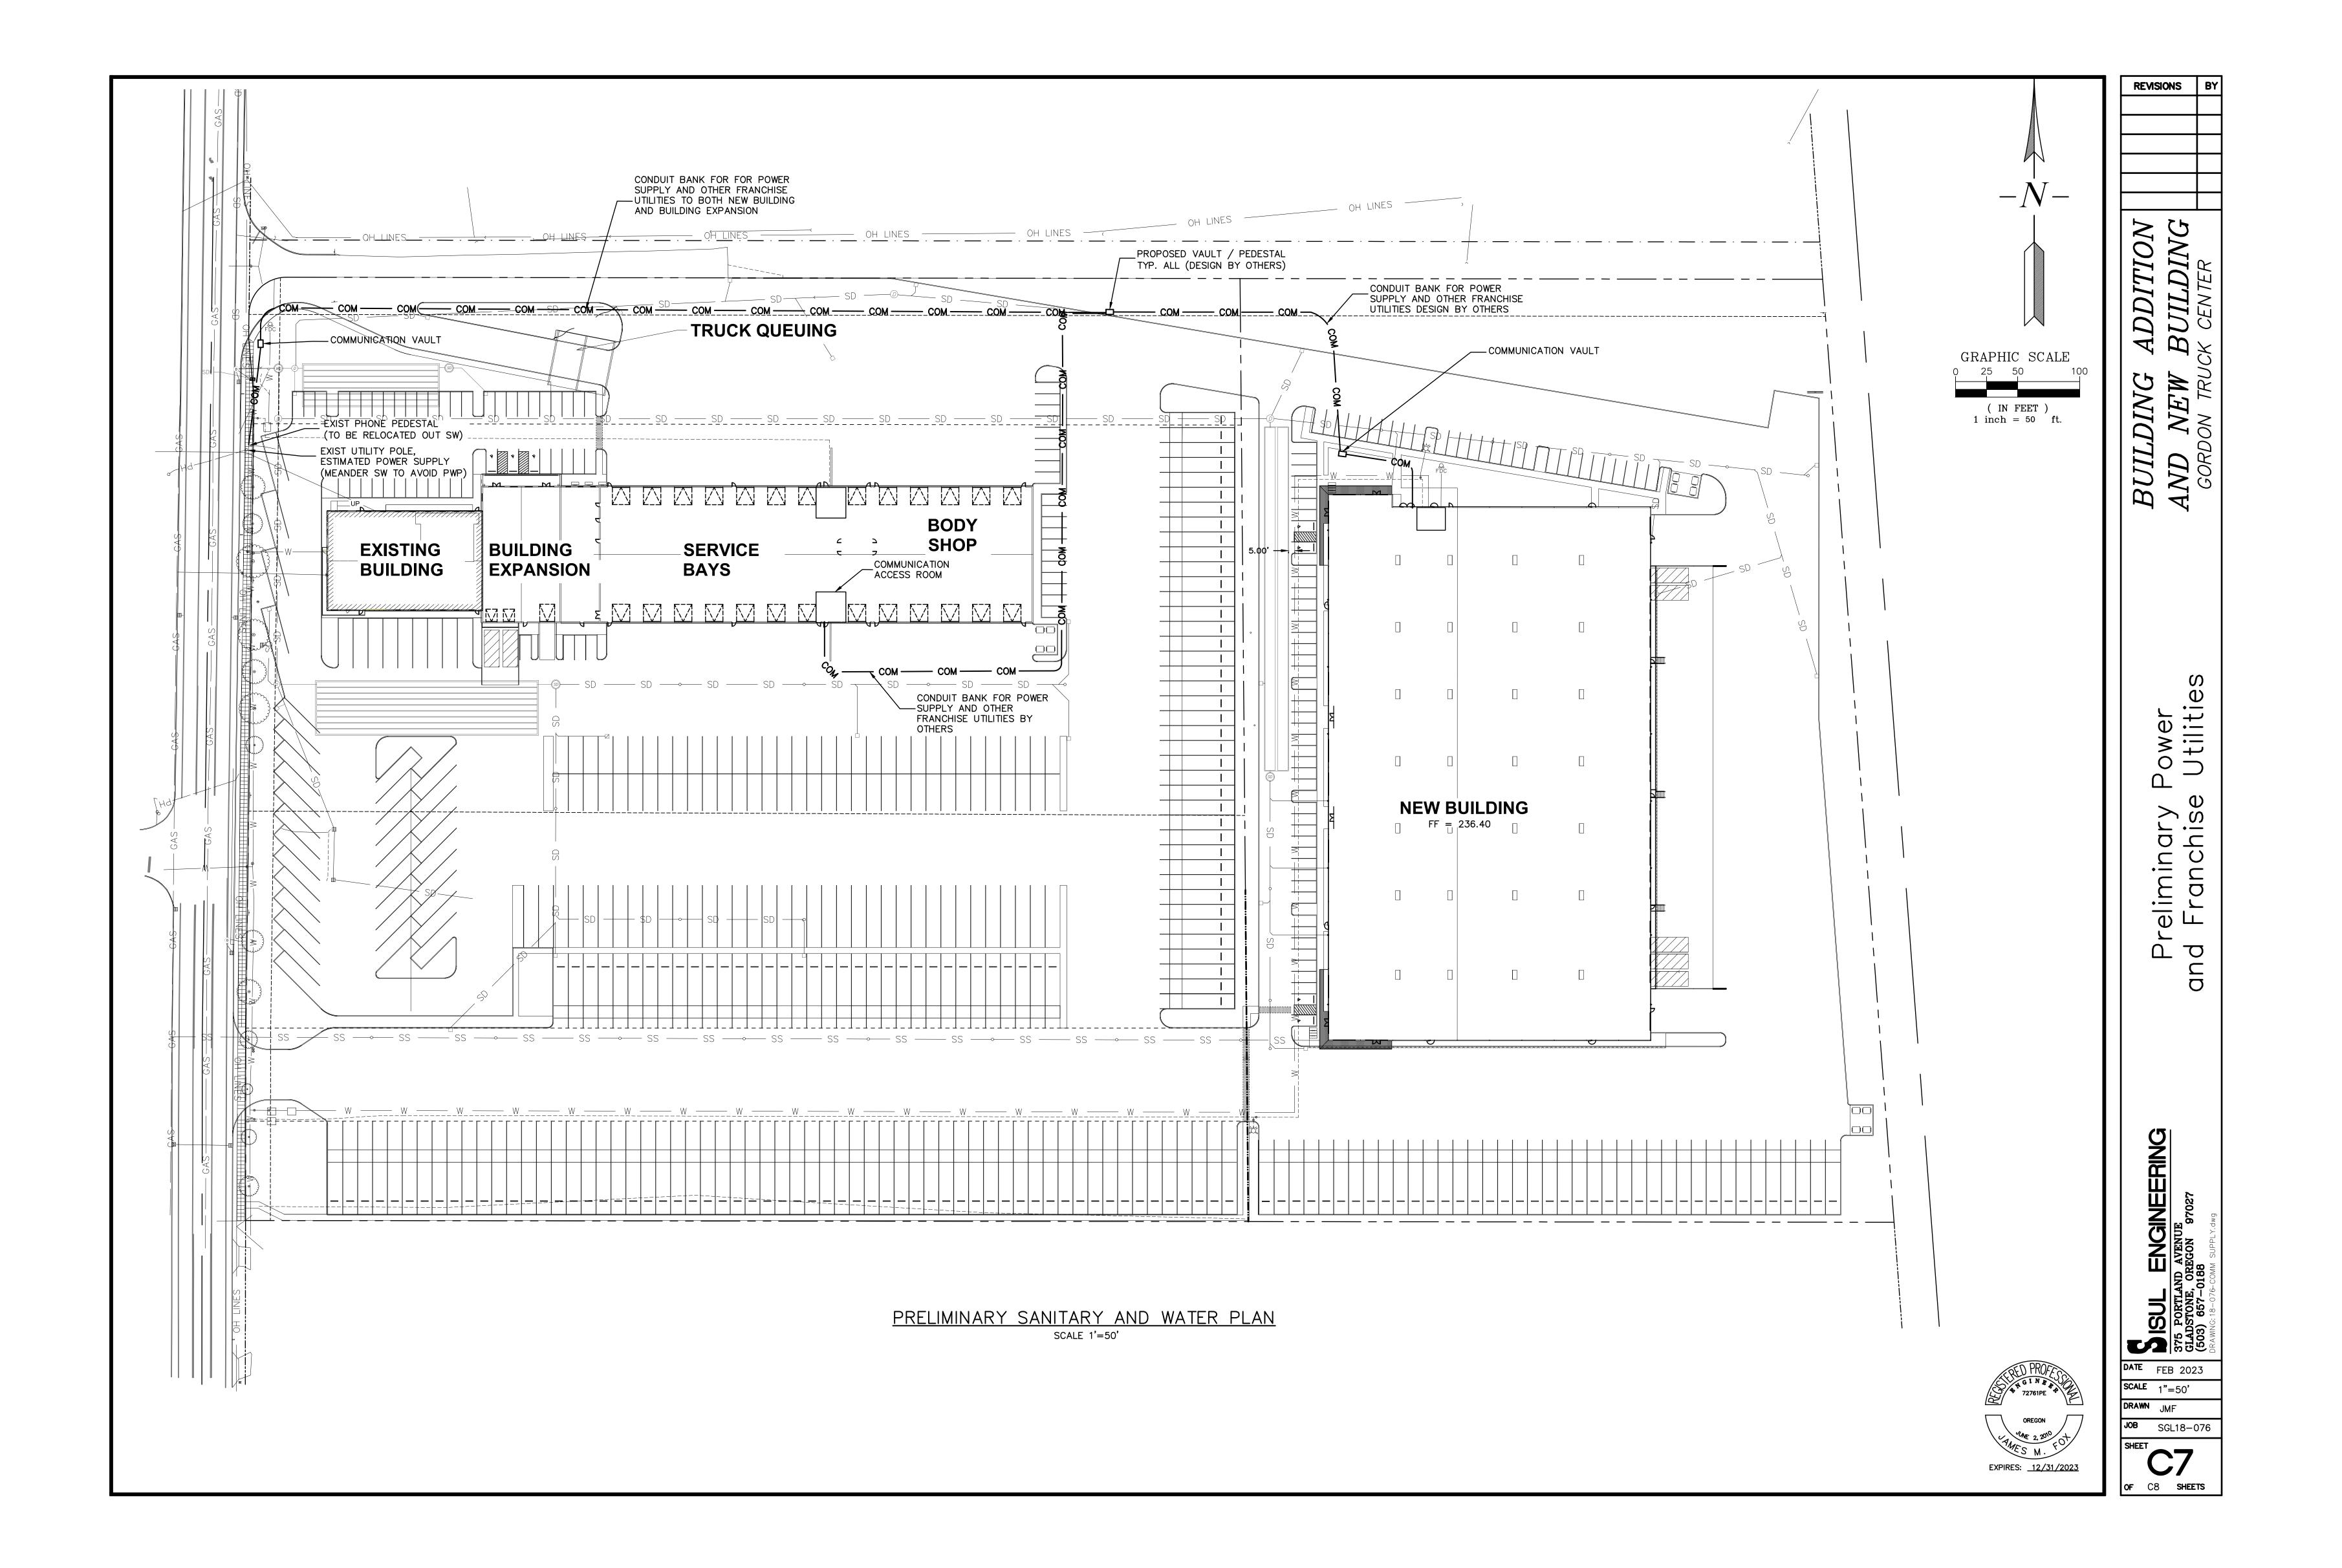

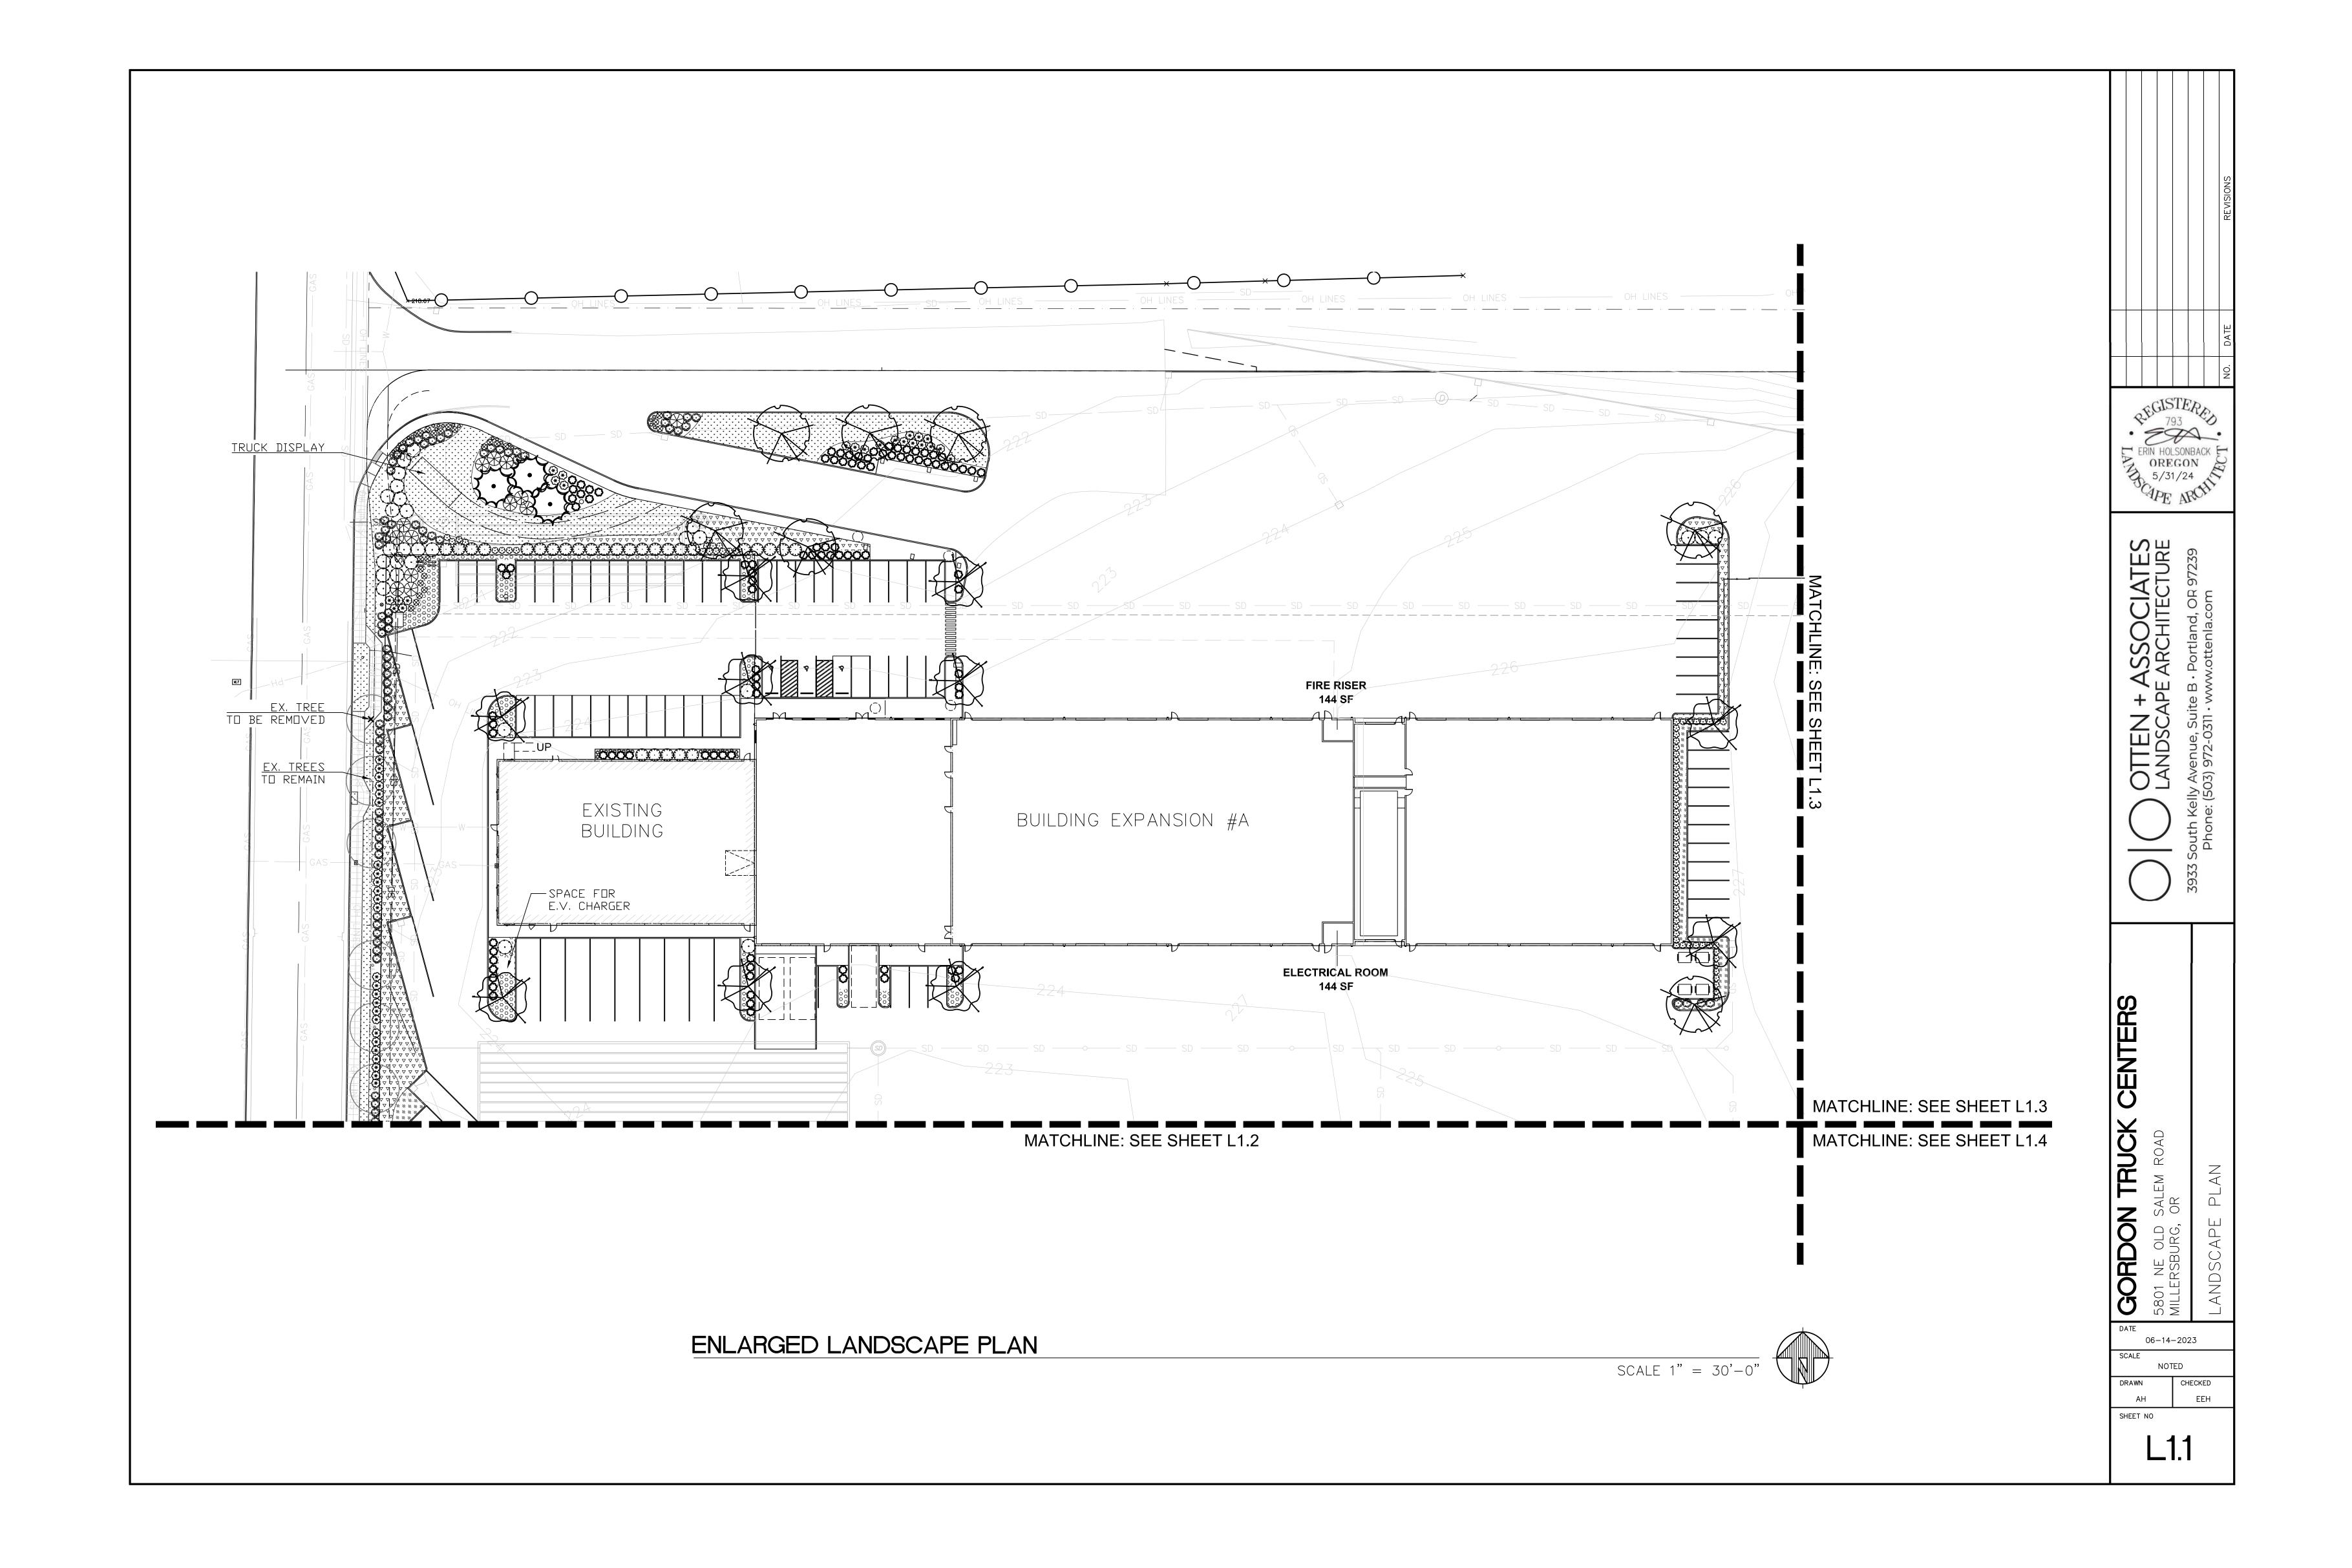

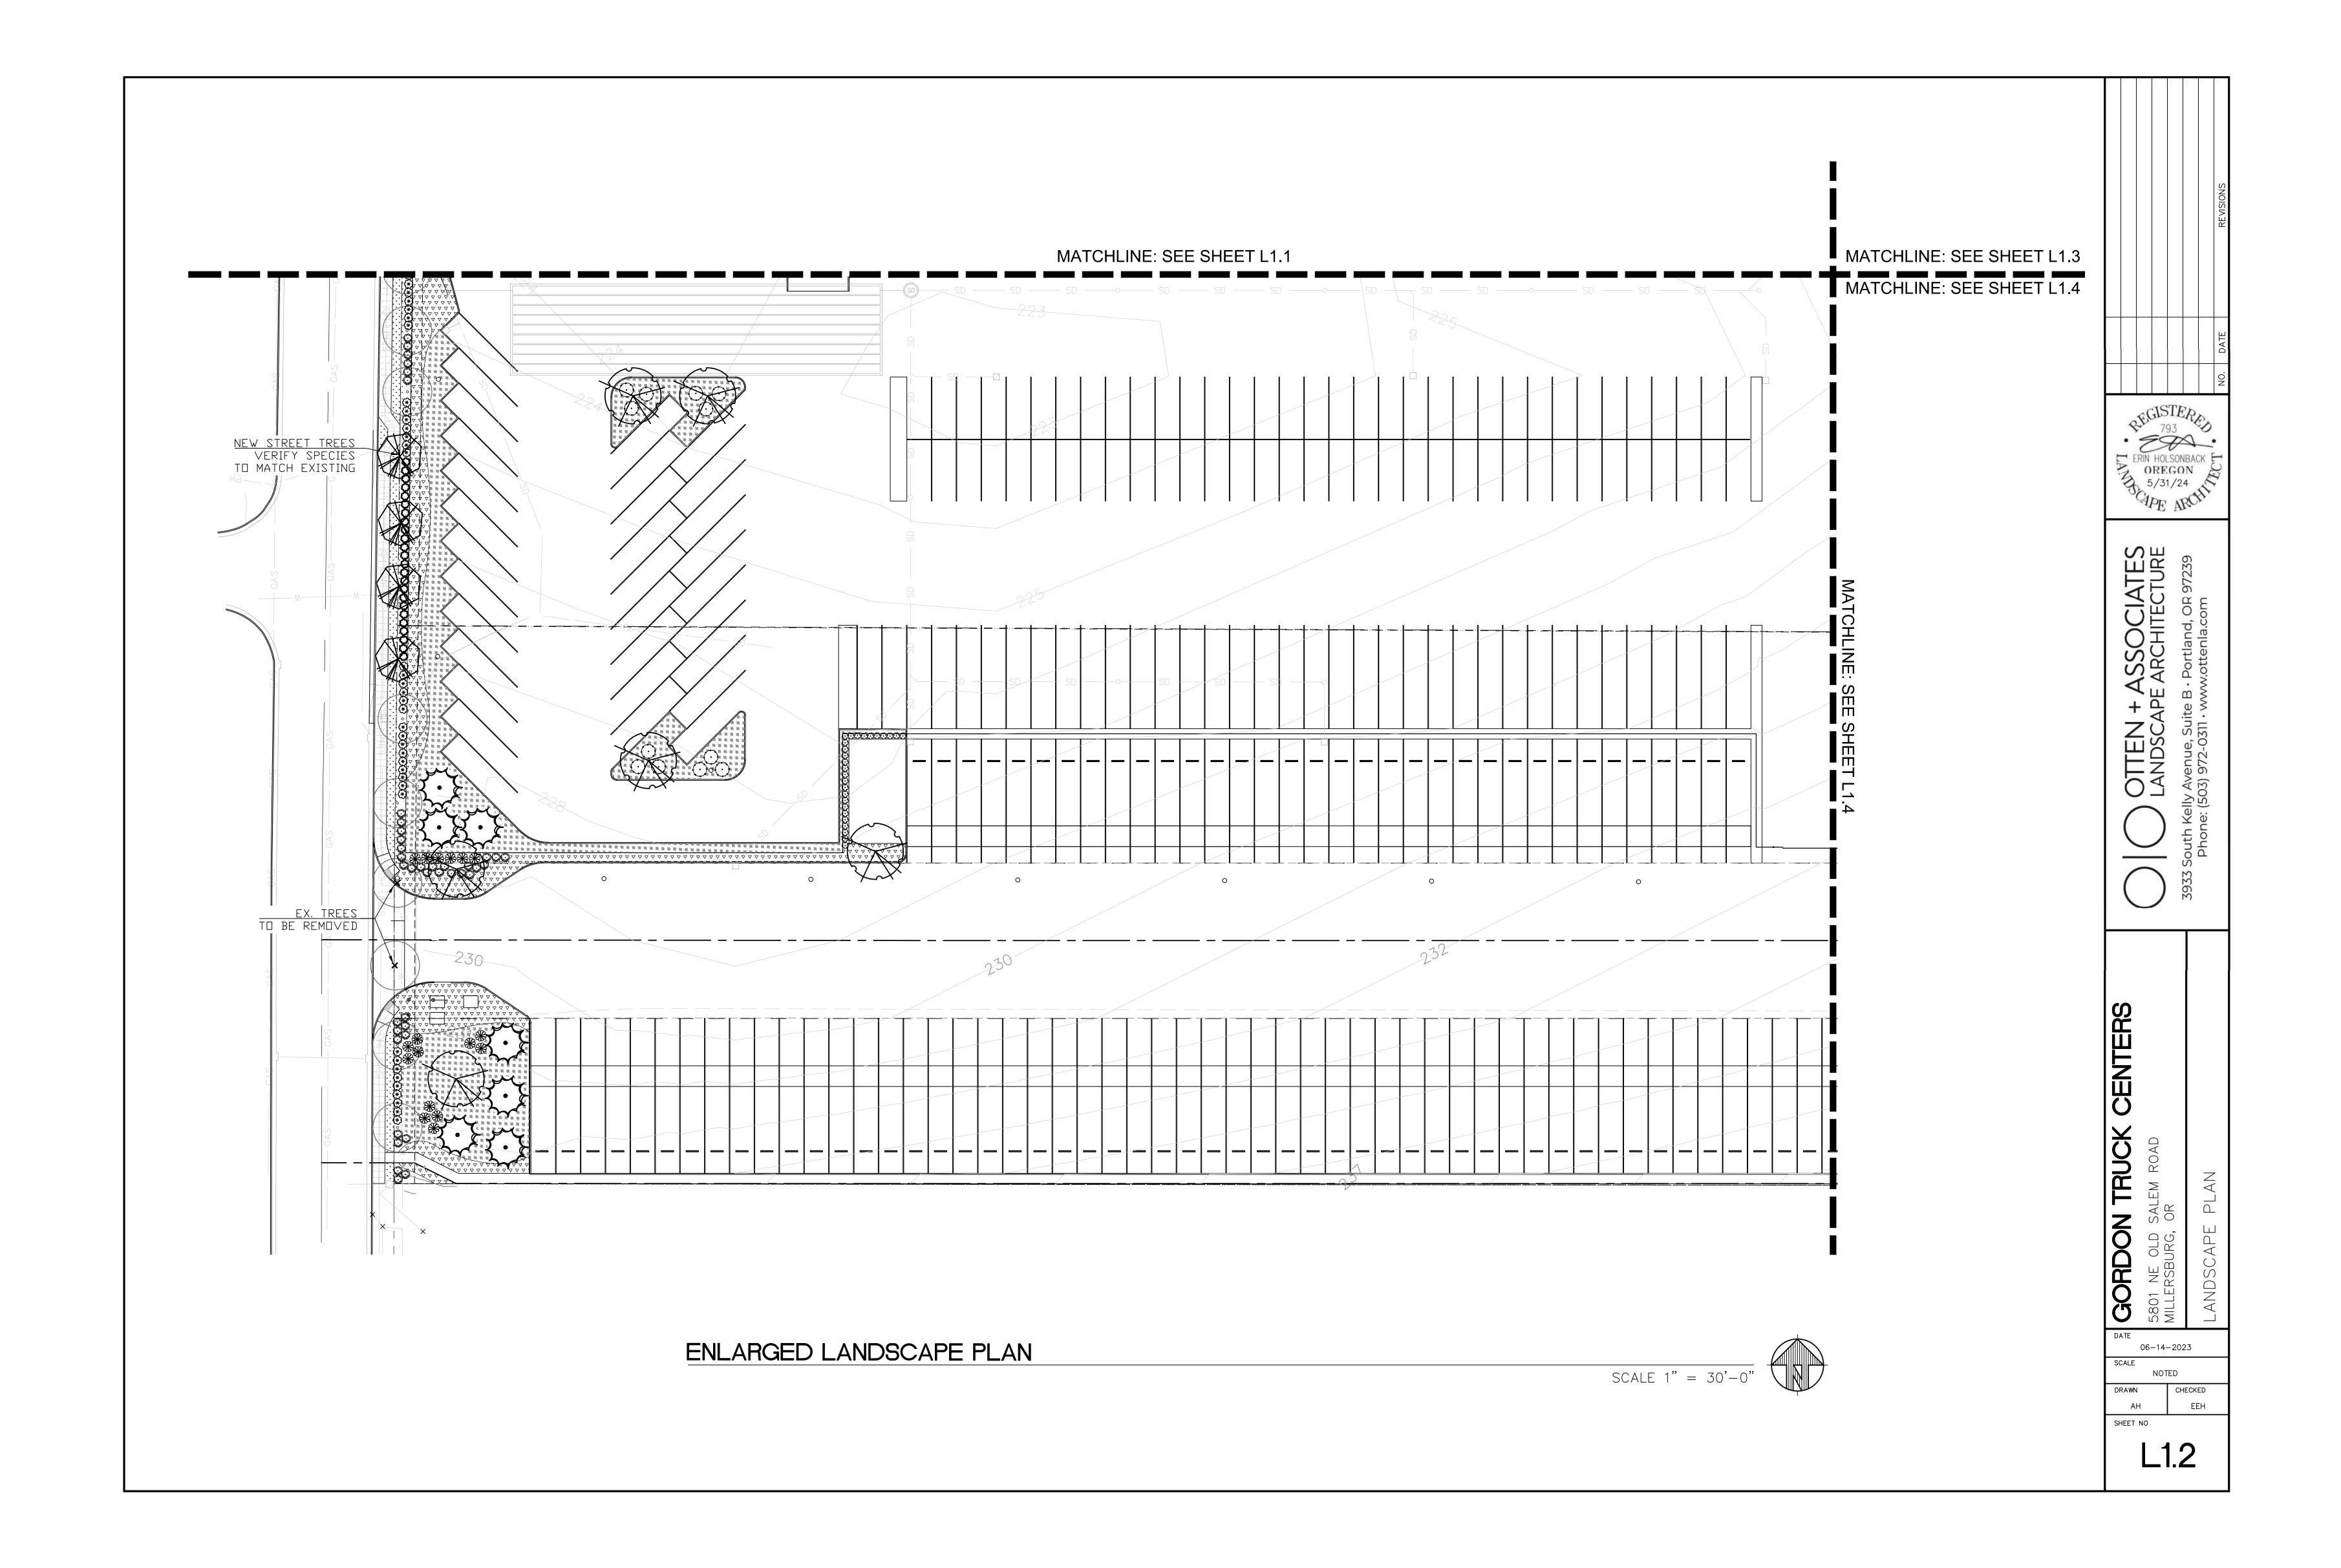

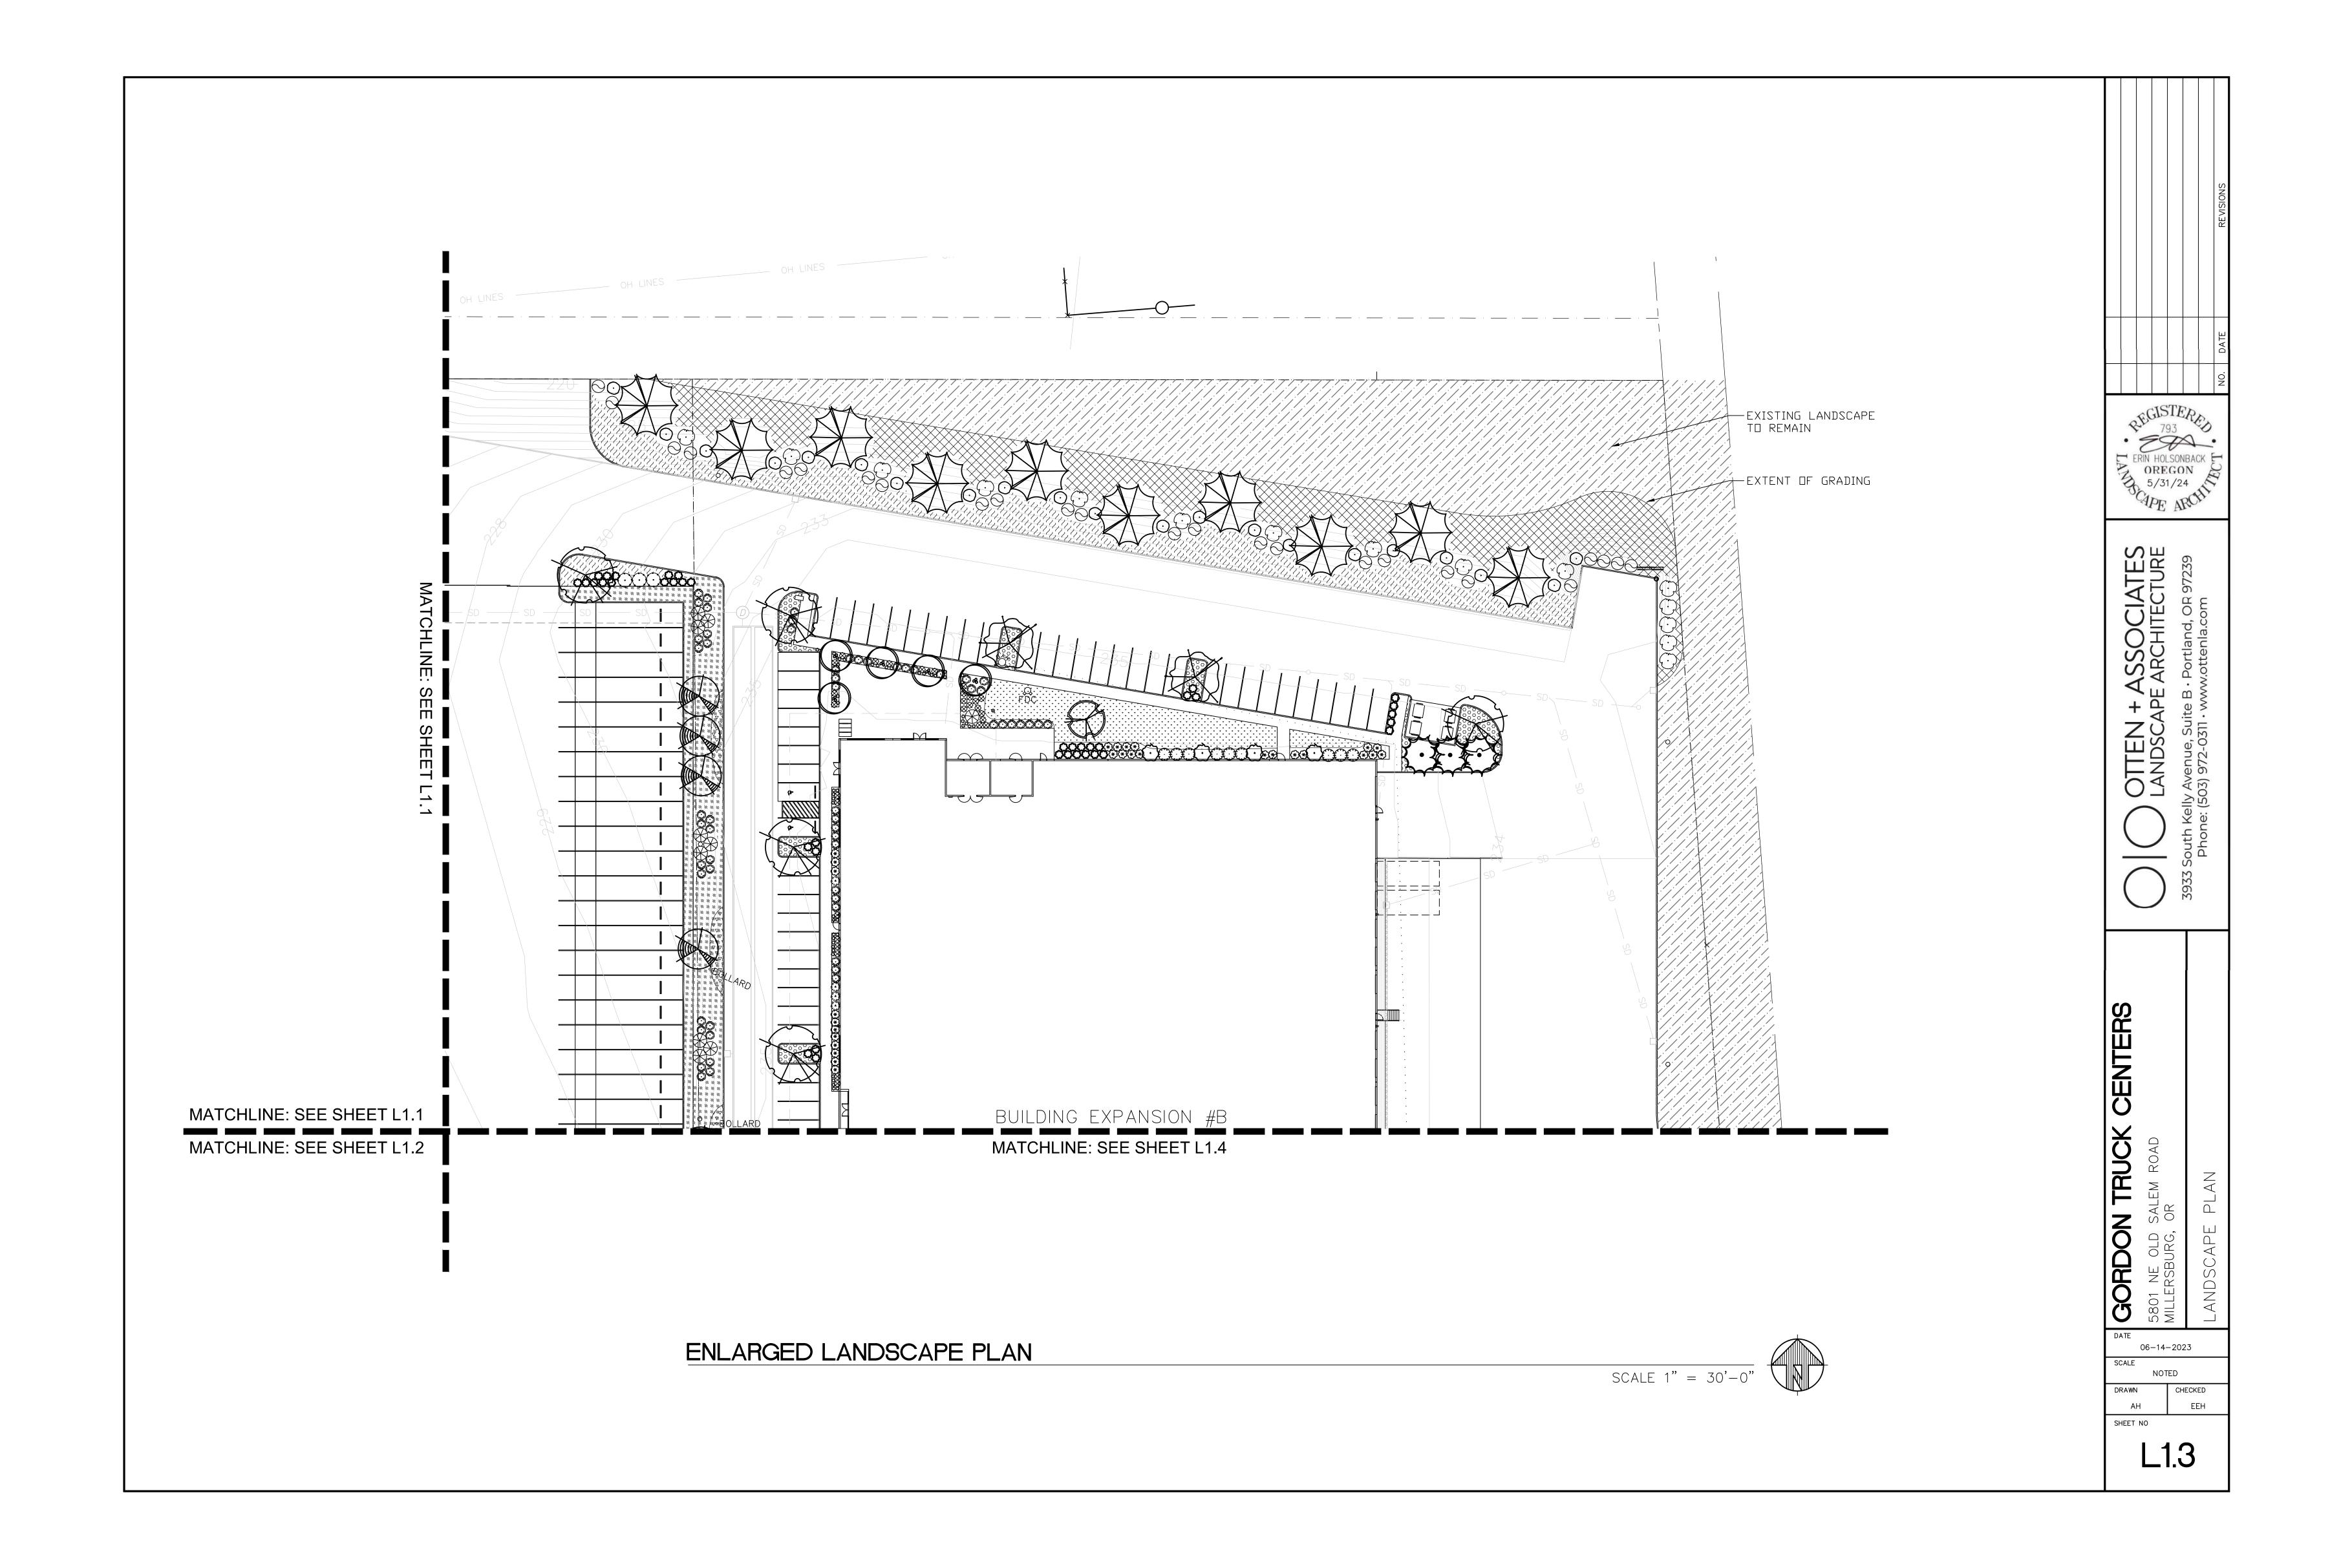

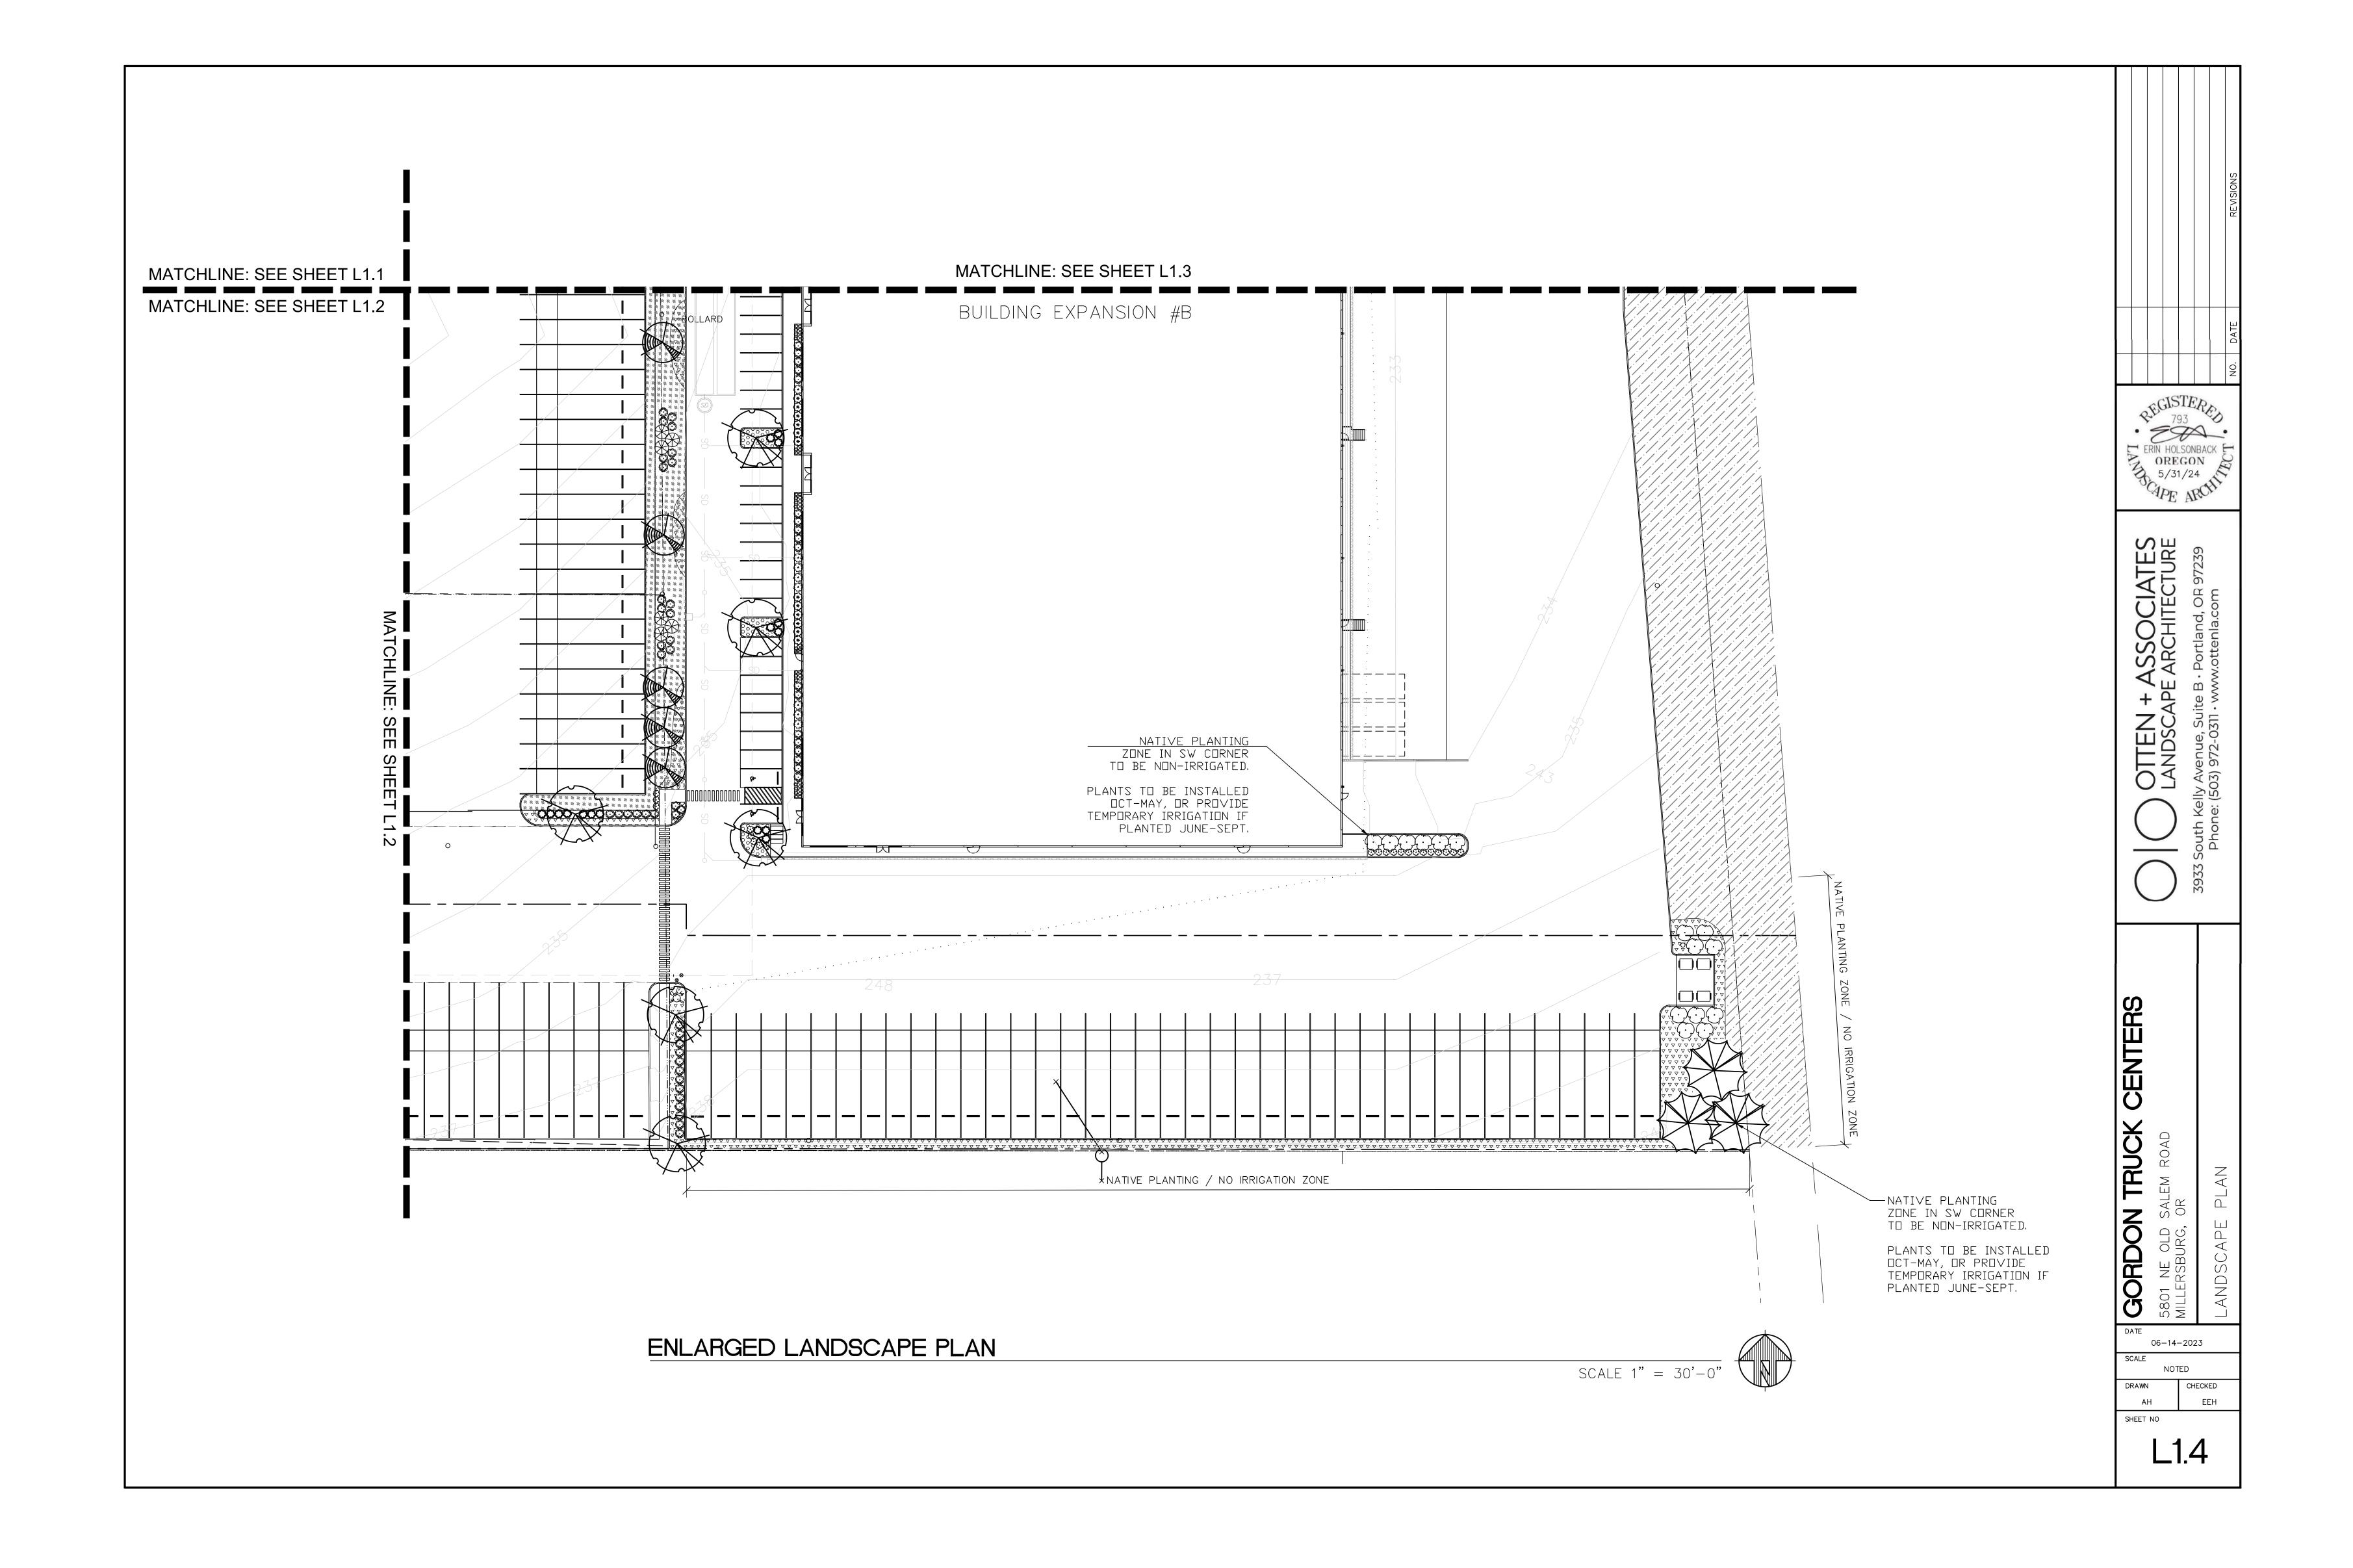

OUTLINE SPECIFICATIONS PLANTING AND SEEDING:

GENERAL: All plants shall conform to all applicable standards of the latest edition of the "American Association of Nurserymen Standards", A.N.S.I. Z60.1 — 1973. Meet or exceed the regulations and laws of Federal, State, and County regulations, regarding the inspection of plant materials, certified as free from hazardous insects, disease, and noxious weeds, and certified fit for sale in Oregon.

The apparent silence of the Specifications and Plans as to any detail, or the apparent omission from them of a detailed description concerning any point, shall be regarded as meaning that only the best general practice is to prevail and that only material and workmanship of first quality are to be used. All interpretations of these Specifications shall be made upon the basis above stated.

Landscape contractor shall perform a site visit prior to bidding to view existing conditions.

PERFORMANCE QUALITY ASSURANCE: Use adequate numbers of skilled workmen who are thoroughly trained and experienced in the necessary horticultural practices and who are completely familiar with the specified requirements and methods needed for the proper performance of the work of this section.

NOTIFICATION: Give Landscape Architect minimum of 2 days advance notice of times for inspections. Inspections at growing site does not preclude Landscape Architect's right of rejection of deficient materials at project site. Each plant failing to meet the above mentioned "Standards" or otherwise failing to meet the specified requirements as set forth shall be rejected and removed immediately from the premises by the Contractor and at his expense, and replaced with satisfactory plants or trees conforming to the specified requirements.

SUBSTITUTIONS: Only as approved by the Landscape Architect or the Owner's Representative.

GUARANTEE AND REPLACEMENT: All plant material shall be guaranteed from final acceptance for one full growing season or one year, whichever is longer. During this period the Contractor shall replace any plant material that is not in good condition and producing new growth (except that material damaged by severe weather conditions, due to Owner's negligence, normally unforeseen peculiarities of the planting site, or lost due to vandalism). Guarantee to replace, at no cost to Owner, unacceptable plant materials with plants of same variety, age, size and quality as plant originally specified. Conditions of guarantee on replacement plant shall be same as for original plant.

Landscape Contractor shall keep on site for Owner's Representative's inspection, all receipts for soil amendment and topsoil deliveries.

PROTECTION: Protect existing roads, sidewalks, and curbs, landscaping, and other features remaining as final work. Verify location of underground utilities prior to doing work. Repair and make good any damage to service lines, existing features, etc. caused by landscaping installation.

PLANT QUALITY ASSURANCE: Deliver direct from nursery. Maintain and protect roots of plant material from drying or other possible injury. Store plants in shade and protect them from weather immediately upon delivery, if not to be planted within four hours.

Nursery stock shall be healthy, well branched and rooted, formed true to variety and species, full foliaged, free of disease, injury, defects, insects, weeds, and weed roots. Trees shall have straight trunks, symmetrical tips, and have an intact single leader. Any trees with double leaders will be rejected upon inspection. All Plants: True to name, with one of each bundle or lot tagged with the common and botanical name and size of the plants in accordance with standards of practice of the American Association of Nurserymen, and shall conform to the Standardized Plant Names, 1942 Edition.

Container grown stock: Small container—grown plants, furnished in removable containers, shall be well rooted to ensure healthy growth. **Grow container plants in containers a minimum of one year** prior to delivery, with roots filling container but not root bound. Bare root stock: Roots well—branched and fibrous. Balled and burlapped (B&B): Ball shall be of natural size to ensure healthy growth. Ball shall be firm and the burlap sound. No loose or made ball will be acceptable.

TOPSOIL AND FINAL GRADES: Landscape Contractor is to supply and place 12" of topsoil in planting beds and 6" in lawn areas. Landscape Contractor is to verify with the General Contractor if the on—site topsoil is or is not conducive to proper plant growth. The topsoil shall be a sandy loam, free of all weeds and debris inimical to lawn or plant growth. Furnish soil analysis by a qualified soil testing laboratory stating percentages of organic matter; gradation of sand, silt and clay content; cation exchange capacity; deleterious material; pH; and plant nutrient content of the topsoil. Report suitablility of topsoil for plant growth and recommended quantities of nitrogen, phosphorus and potash nutrients and soil amendments (including compost) to be added to produce satisfactory topsoil. If stockpiled topsoil on site is not conducive to proper

Landscaping shall include finished grades and even distribution of topsoil to meet planting requirements. Grades and slopes shall be as indicated. Planting bed grades shall be approximately 3" below adjacent walks, paving, finished grade lines, etc., to allow for bark application. Finish grading shall remove all depressions or low areas to provide positive drainage throughout the area.

PLANTING SPECIFICATIONS:

SOIL PREPARATION: Work all areas by rototilling to a minimum depth of 8". Remove all stones (over 1½" size), sticks, mortar, large clumps of vegetation, roots, debris, or extraneous matter turned up in working. Soil shall be of a homogeneous fine texture. Level, smooth and lightly compact area to plus or minus .10 of required grades.

In groundcover areas add 2" of compost (or as approved) and till in to the top 6" of soil.

PLANTING HOLE: Lay out all plant locations and excavate all soils from planting holes to 2 1/2 times the root ball or root system width. Loosen soil inside bottom of plant hole. Dispose of any "subsoil" or debris from excavation. Check drainage of planting hole with water, and adjust any area showing drainage problems.

SOIL MIX: Prepare soil mix in each planting hole by mixing:

2 part native topsoil (no subsoil)
1 part compost (as approved)

Thoroughly mix in planting hole and add fertilizers at the following rates:

plant growth, the Landscape Contractor shall import the required amount.

Small shrubs — 1/8 lb./ plant Shrubs — 1/3 to 1/2 lb./ plant

Shrubs - 1/3 to 1/2 lb./ plant Trees - 1/3 to 1 lb./ plant

FERTILIZER: For trees and shrubs use Commercial Fertilizer "A" Inorganic (5-4-3) with micro-nutrients and 50% slow releasing nitrogen. For initial application in fine seed lawn areas use Commercial Fertilizer "B" (8-16-8) with micro-nutrients and 50% slow-releasing nitrogen. For lawn maintenance use Commercial Fertilizer "C" (22-16-8) with micro-nutrients and 50% slow-releasing nitrogen. DO NOT apply fertilizer to Water Quality Swale.

PLANTING TREES AND SHRUBS: Plant upright and face to give best appearance or relationship to adjacent plants and structures. Place 6" minimum, lightly compacted layer of prepared planting soil under root system. Loosen and remove twine binding and burlap from top 1/2 of root balls. Cut off cleanly all broken or frayed roots, and spread roots out. Stagger Plants in rows. Backfill planting hole with soil mix while working each layer to eliminate voids.

When approximately 2/3 full, water thoroughly, then allow water to soak away. Place remaining backfill and dish surface around plant to hold water. Final grade should keep root ball slightly above surrounding grade, not to exceed 1". Water again until no more water is absorbed. Initial watering by irrigation system is not allowed.

STAKING OF TREES: Stake or guy all trees. Stakes shall be 2" X 2" (nom.) quality tree stakes with point. They shall be of Douglas Fir, clear and sturdy. Stake to be minimum 2/3 the height of the tree, not to exceed 8'-0". Drive stake firmly 1'-6" below the planting hole. Tree ties for deciduous trees shall be "Chainlock" (or better). For Evergreen trees use "Gro-Strait" Tree Ties (or a reinforced rubber hose and guy wires) with guy wires of a minimum 2 strand twisted 12 ga. wire. Staking and guying shall be loose enough to allow movement of tree while holding tree upright. Tree stakes shall be removed after one year.

MULCHING OF PLANTINGS: Prior to mulch installation, apply granulated pre—emergent herbicide to all planting areas according to manufacturer's instructions. Mulch all planting areas with dark, aged, medium grind fir or hemlock bark (aged at least 6 months) to a depth of 2" in ground cover areas and 2½" in shrub beds. Apply evenly, not higher than grade of plant as it came from the nursery, and rake to a smooth finish. Water thoroughly, then hose down planting area with fine spray to wash leaves of plants.

FINE LAWN AREAS: In fine lawn area apply Commercial Fertilizer Mix "B" at 4.5 lbs. Per 1,000 sq.ft. and rake into soil surface. Establish an even, fine textured seedbed meeting grades, surfaces and texture. Sow seed with a mechanical spreader at the uniform rates as noted below. Rake seed lightly to provide cover.

ROUGH SEED AREA: In rough seeded area, establish an evenly graded seedbed. Sow seed with a mechanical spreader at the uniform rates as noted below. Rake seed

lightly to provide cover.

SEED: Bluetag grass seed conforming to applicable State laws. No noxious weed seeds. Submit Guaranteed analysis.

Fine Lawn Seed Mix: To contain 50% Top Hat Perennial Ryegrass, 30% Derby Supreme Ryegrass, 20% Longfellow Chewings Fescue (Hobbs and Hopkins Pro—Time 303 Lawn Mix or as approved) Sow Seed at 5 lbs. / 1000 sq. ft.

Meadow Seed Mix: To Contain: 50% grasses, 40% perennial flowers, and 10% annual flowers (Pro—Time 454 Native Urban Meadow Mix, or approved equal). Sow at 2 lbs. Per 1,000 sq.ft.


MAINTENANCE OF SEEDED AREAS:

Fine Lawn Areas: The lawn areas shall be maintained by watering, mowing, reseeding, and weeding for a minimum of 60 days after seeding. After 30 days, or after the second mowing, apply Commercial Fertilizer Mix "C" at 5 lbs. per 1,000 sq. ft. Mow and keep at 1½" to 2" in height. Remove clippings and dispose of off site.


Meadow Areas: The meadow areas shall be maintained by watering, reseeding, and weeding for a minimum of 60 days after seeding. Mow as needed to maintain area.

GENERAL MAINTENANCE: Protect and maintain work described in these specifications against all defects of materials and workmanship, through final acceptance. Replace plants not in normal healthy condition at the end of this period. Water, weed, cultivate, mulch, reset plants to proper grade or upright position, remove dead wood and do necessary standard maintenance operations. Irrigate when necessary to avoid drying out of plant materials, and to promote healthy growth.


CLEAN—UP: At completion of each division of work all extra material, supplies, equipment, etc., shall be removed from the site. All walks, paving, or other surfaces shall be swept clean, mulch areas shall have debris removed and any soil cleared from surface. All areas of the project shall be kept clean, orderly and complete.

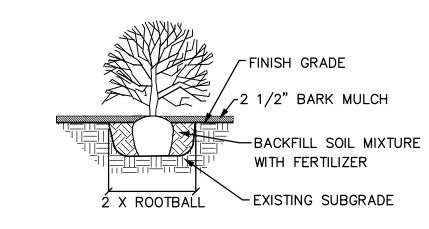



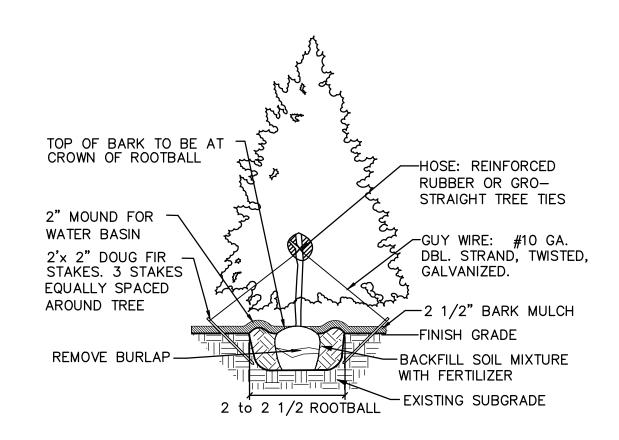




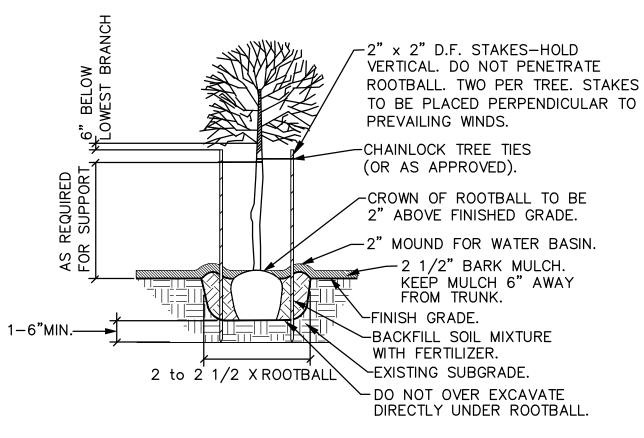


NOTE: ANY PROPOSED CHANGES TO OUR SPECIFICATION OR DETAIL SHOULD BE APPROVED BY THE LANDSCAPE ARCHITECT. LIKEWISE, IN ACCORDANCE WITH BEST PRACTICES OF LOCAL LANDSCAPE INSTALLATION, SHOULD THE LANDSCAPE CONTRACTOR FIND A PREFERRED ALTERNATE METHOD, THE LANDSCAPE ARCHITECT MAY BE SO ADVISED.

GENERAL DECIDUOUS TREE PLANTING DETAIL

NOT TO SCALE

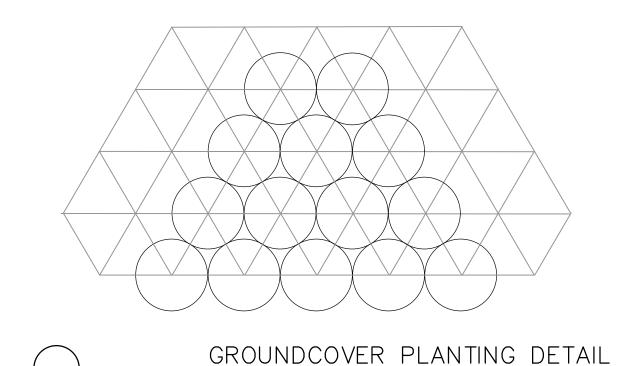

NOT TO SCALE

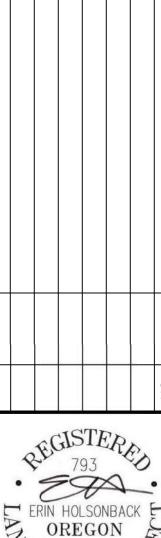

ASSOCIATES

E ARCHITECTURE

B · Portland, OR 97239

ww.ottenla.com

OTTEN + AS LANDSCAPE A LANDSCAPE A Phone: (503) 972-0311 · www.

N TRUCK CENTER
SALEM ROAD
OR

DATE

06-14-2023

SCALE

NOTED


DRAWN

CHECKED

AH

EEH

L2.C

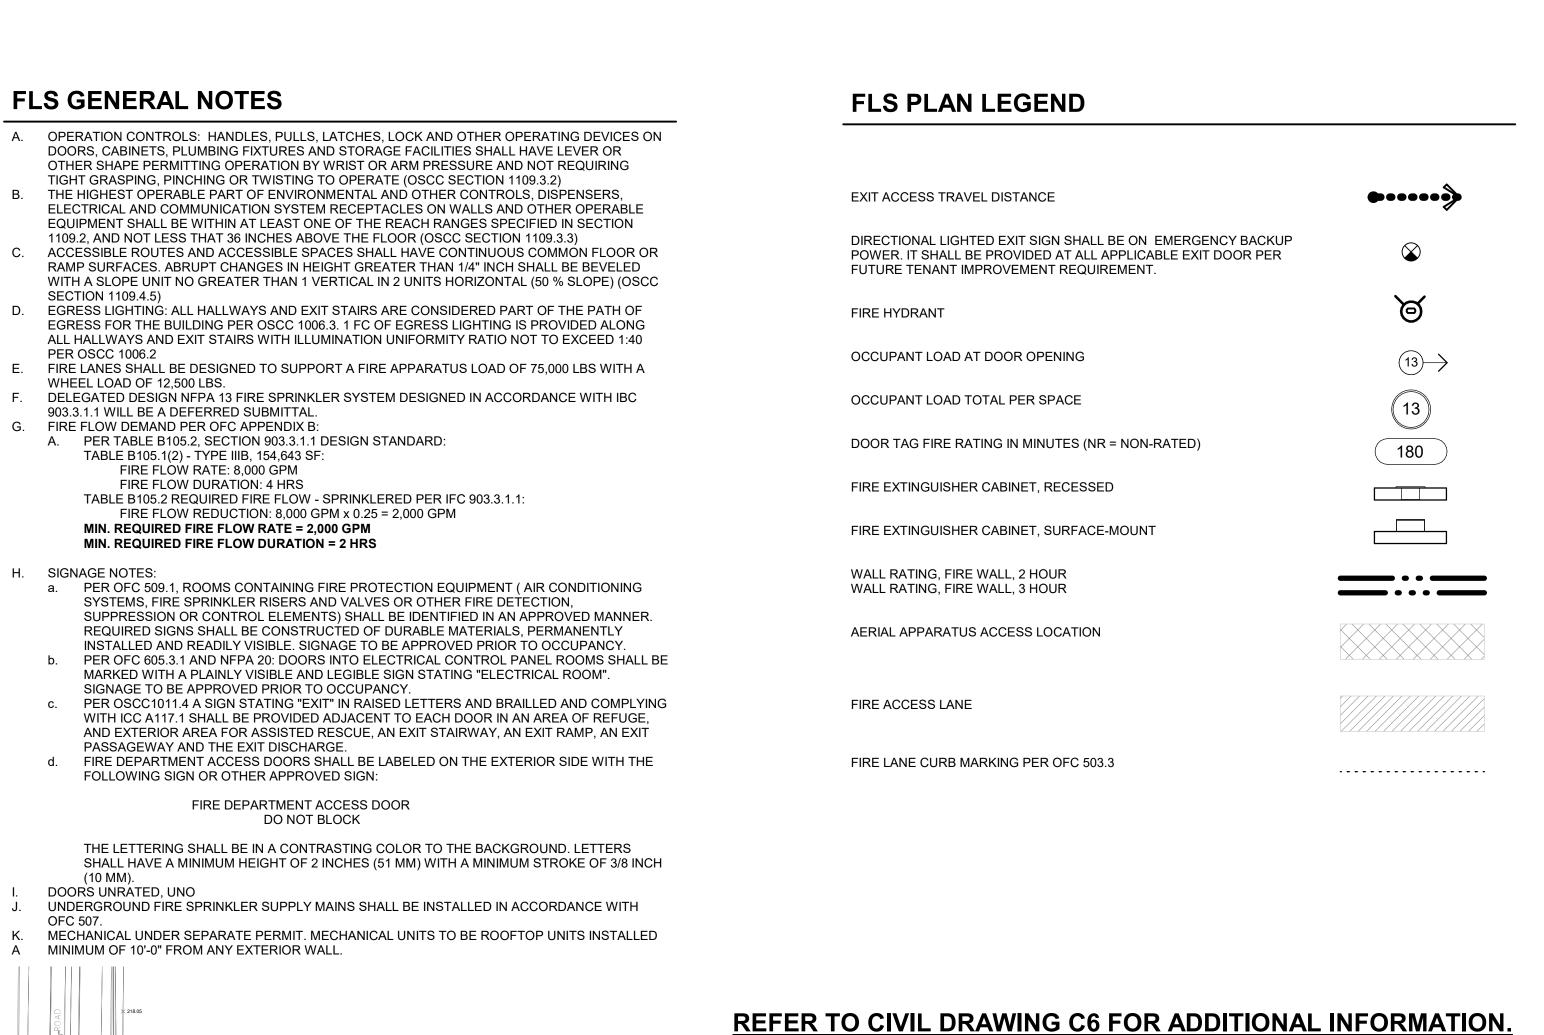

FIRE RISER
(SP-056) 144 SF

SP-055 ELECTRICAL ROOM 144 SF

36

34

61

BODY

SHOP

FF ELEV = 226.36

SERVICE

BAYS

KEYNOTES

SP-001 PROPERTY LINE

435.8.4

SP-028

40

SP-012 ACCESSIBLE ROUTE TO ROW

SP-045 FIRE APPARATUS ACCESS LANE

SP-053 ROOF ACCESS PLATFORM ABOVE

SP-054 ROOF ACCESS HATCH OVERHEAD

SP-052 LADDER, ROOF ACCESS

SP-028 KNOX BOX, COORDINATE FINAL LOCATION(S) WITH FIRE MARSHAL

SP-047 FUTURE EXTERIOR AREA OF ASSISTED RESCUE PER OSSC 1009.7

PER OFC 503.3 & SIGNAGE PER APPENDIX D 103.6

SP-055 'ELECTRICAL ROOM' SIGNAGE AT EXTERIOR DOOR

SP-056 'FIRE RISER ROOM' SIGNAGE AT EXTERIOR DOOR

SP-064 CANOPY STRUCTURE OVERHEAD, 16'-0" CLEAR

SP-029 FIRE LANE CURB PAINTED YELLOW, MARKED "NO PARKING FIRE LANE"

SP-035 FIRE DEPARTMENT ACCESS DOORS PER OSSC TABLE 435.5.1 & SECTION

PROPOSED FDC

ELECTRICAL ROOM
348 SF

NEW BUILDING #B

GROSS AREA 112,320 SF

FF ELEV = 236.40 T.O. PARAPET @ HIGHEST LOCATION IS 43'-0"

130' - 0"

FIRE APPARATUS ACCESS ROADWAYS

(39)



NOT FOR CONSTRUCTION

Client/ Owner:

GORDON

CENTERS

BUILDING

ADDITION

5801 NE OLD SALEM ROAD

SITE PLAN -

RESPONSE

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121143

MILLERSBURG, OR

Sheet Title:

FIRE

TRUCK

CLIENT ADDR

SP-035

SITE PLAN - FIRE RESPONSE

ENTRY ACCESS

212)

EXISTING

BUILDING


10,000 SF (MAIN) 2,000 SF (UPPER)

BUILDING

EXPANSION #A
48,850 SF (MAIN LEVEL)

3,000 SF (UPPER) 7.O. HIGHEST RIDGE 39'-1 3/8"

DESIGN REVIEW - JUNE 2023

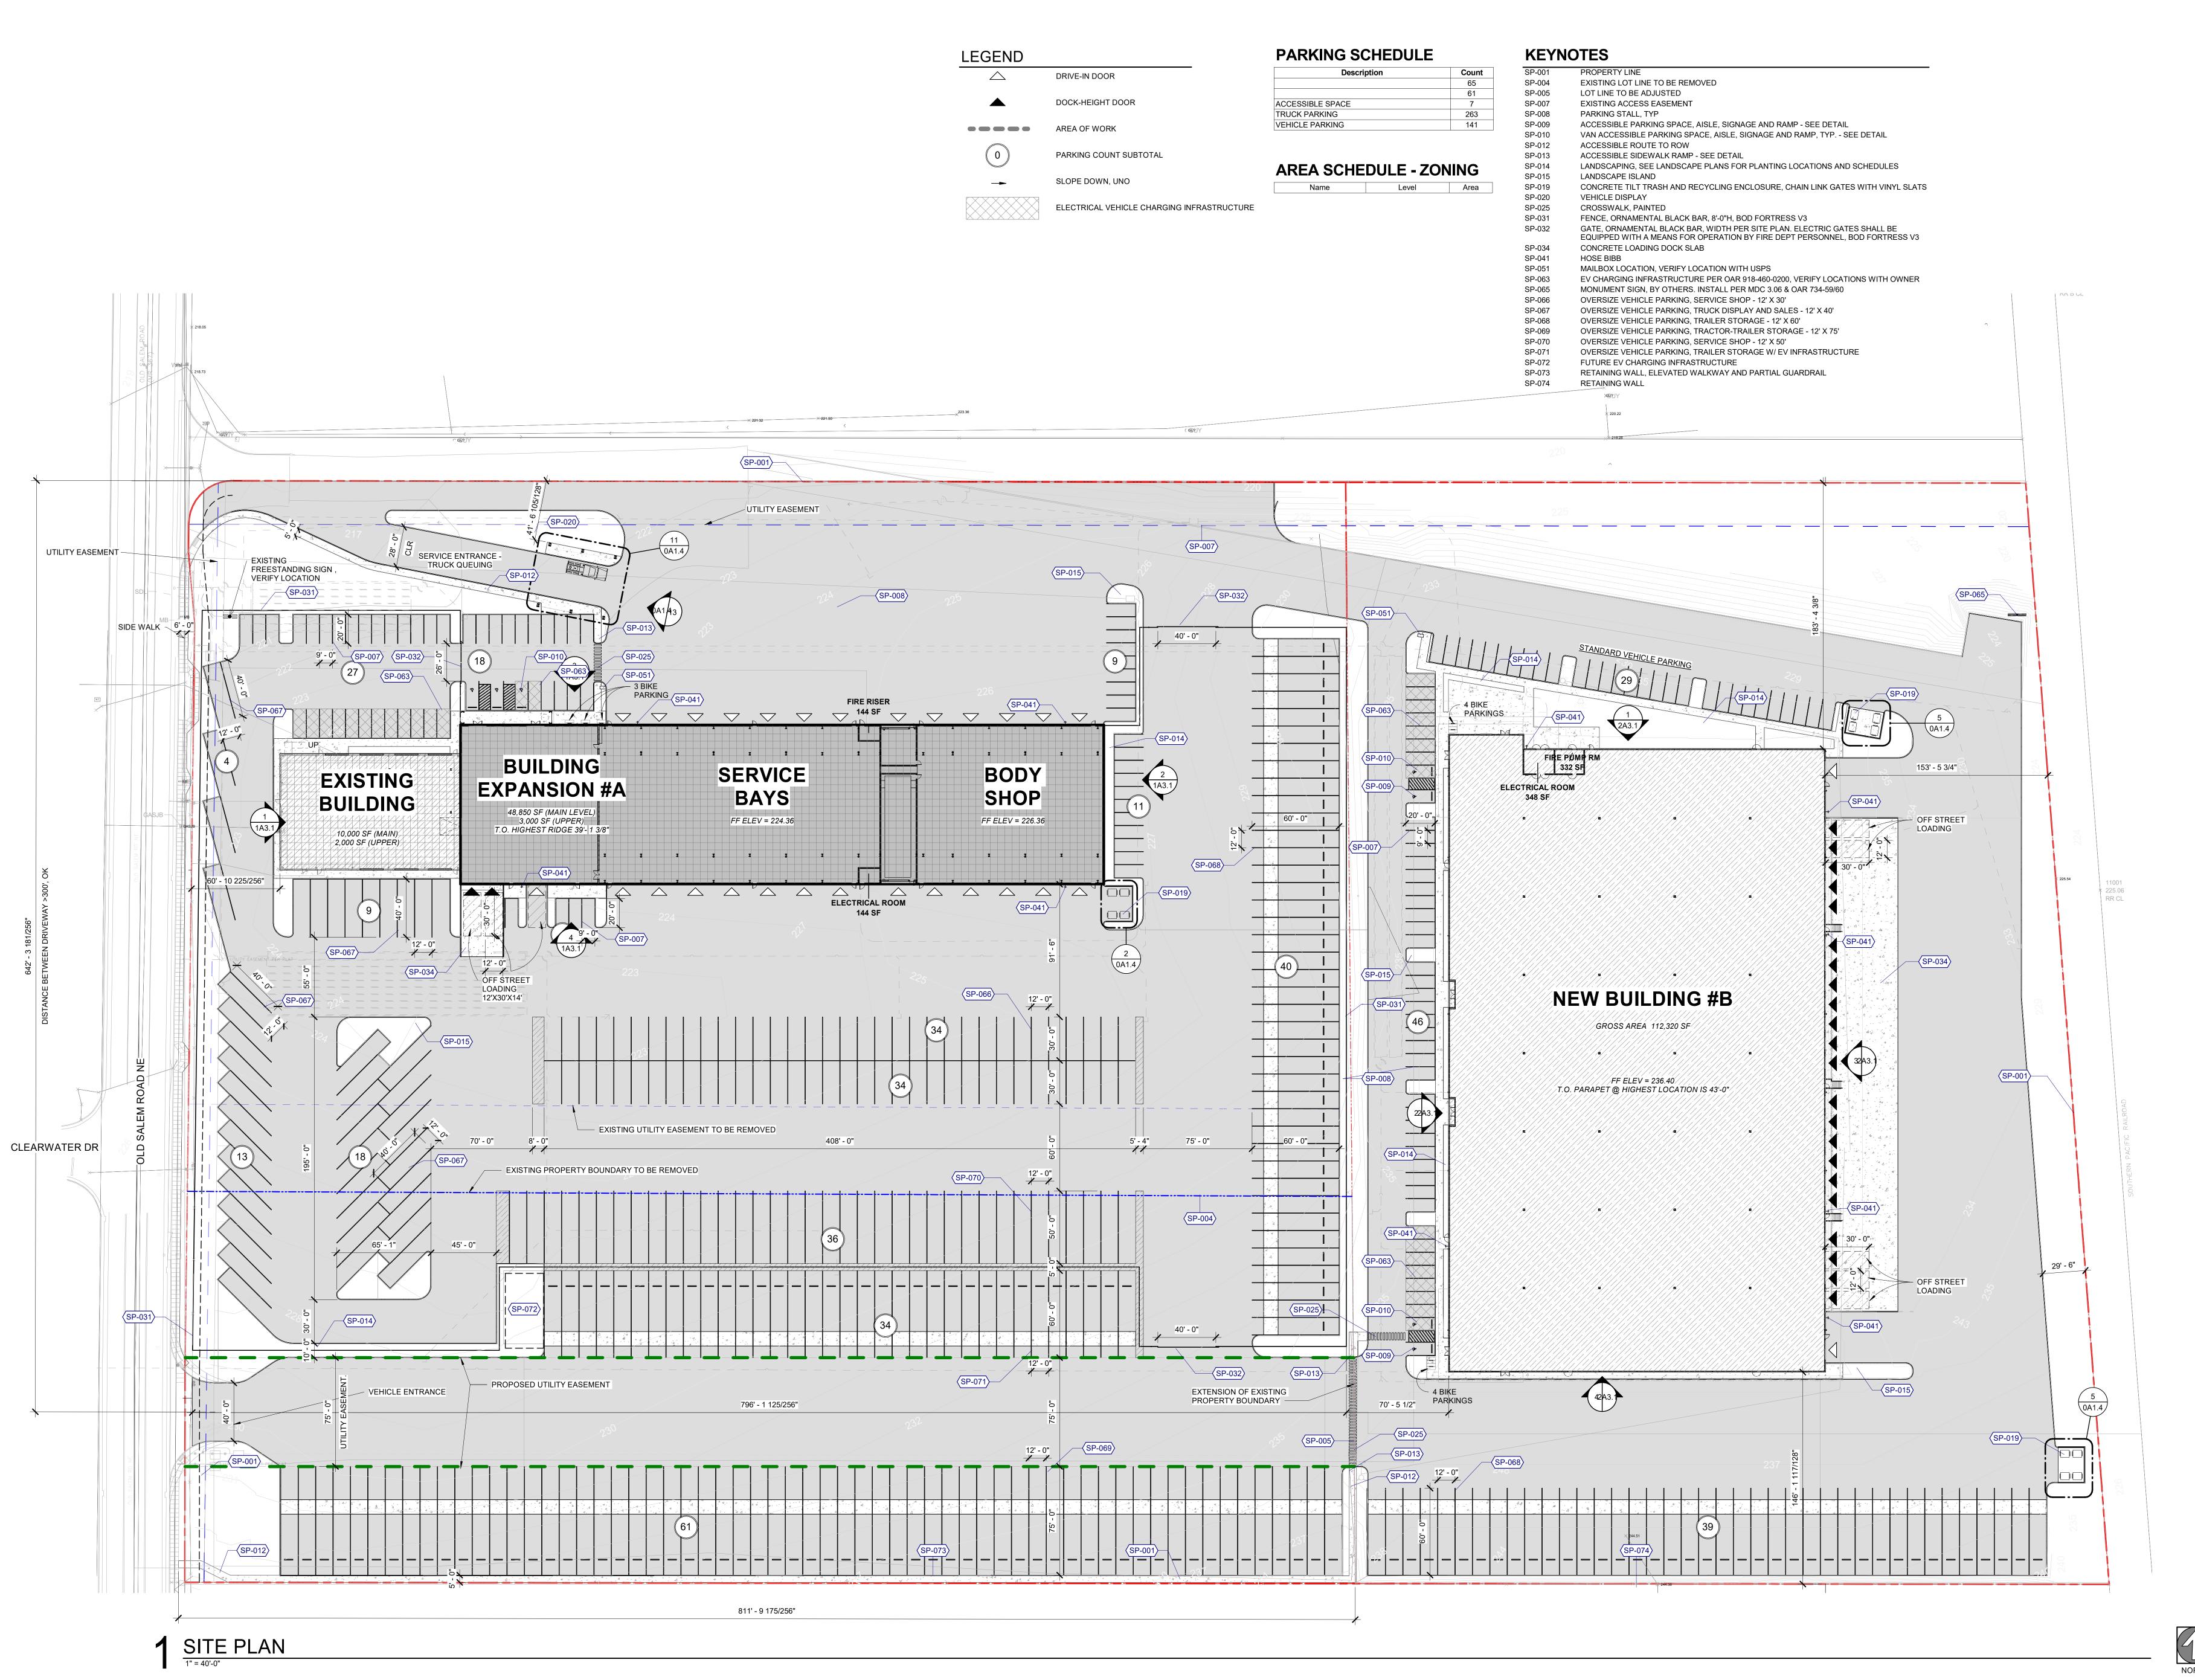



Client/ Owner:

GORDON TRUCK CENTERS

CLIENT ADDR

BUILDING ADDITION

5801 NE OLD SALEM ROAD MILLERSBURG, OR

SITE PLAN

Sheet Title:

evisions:


Description


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Date: 6/20/2023

Job Number: 121143



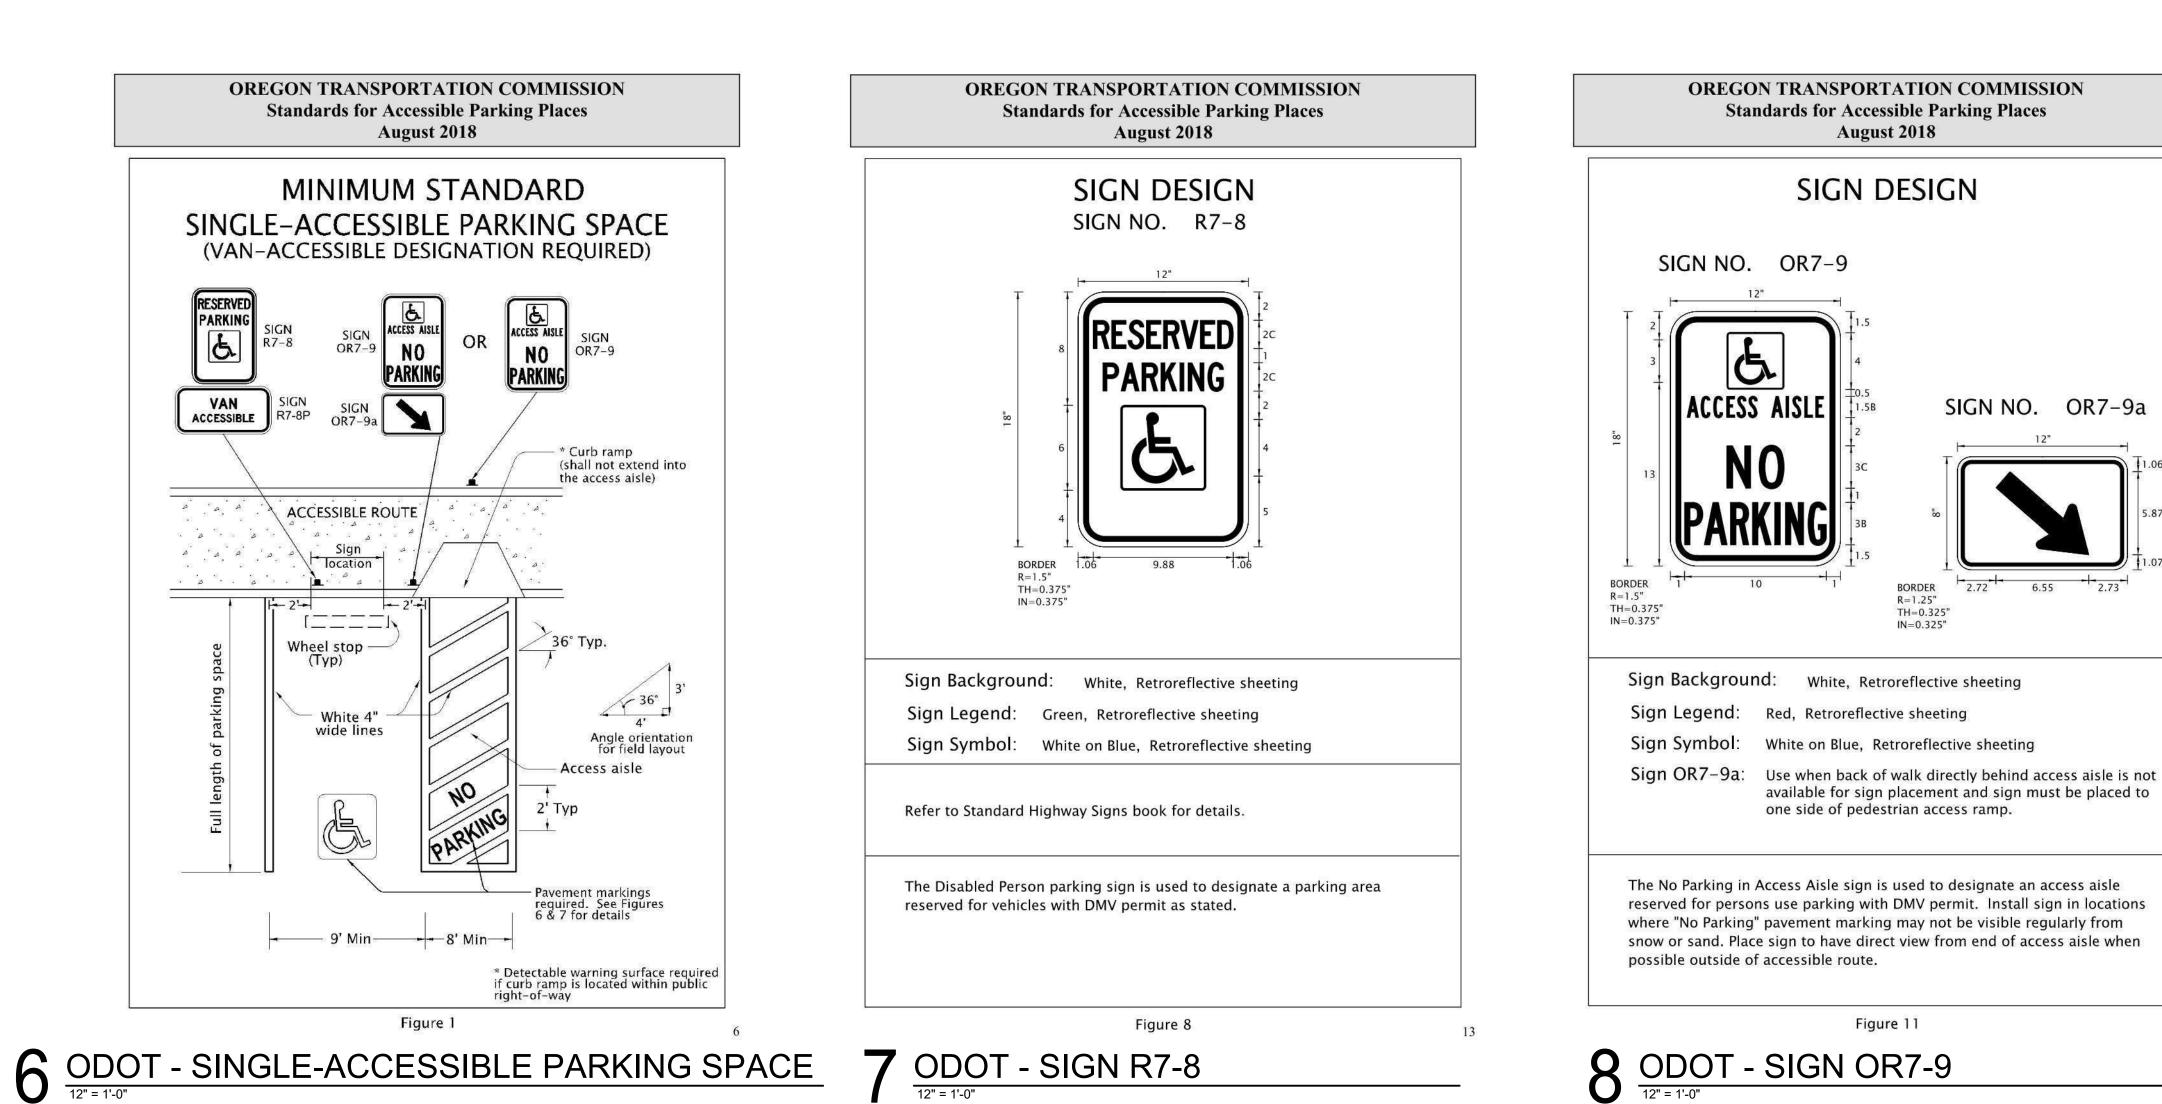


August 2018

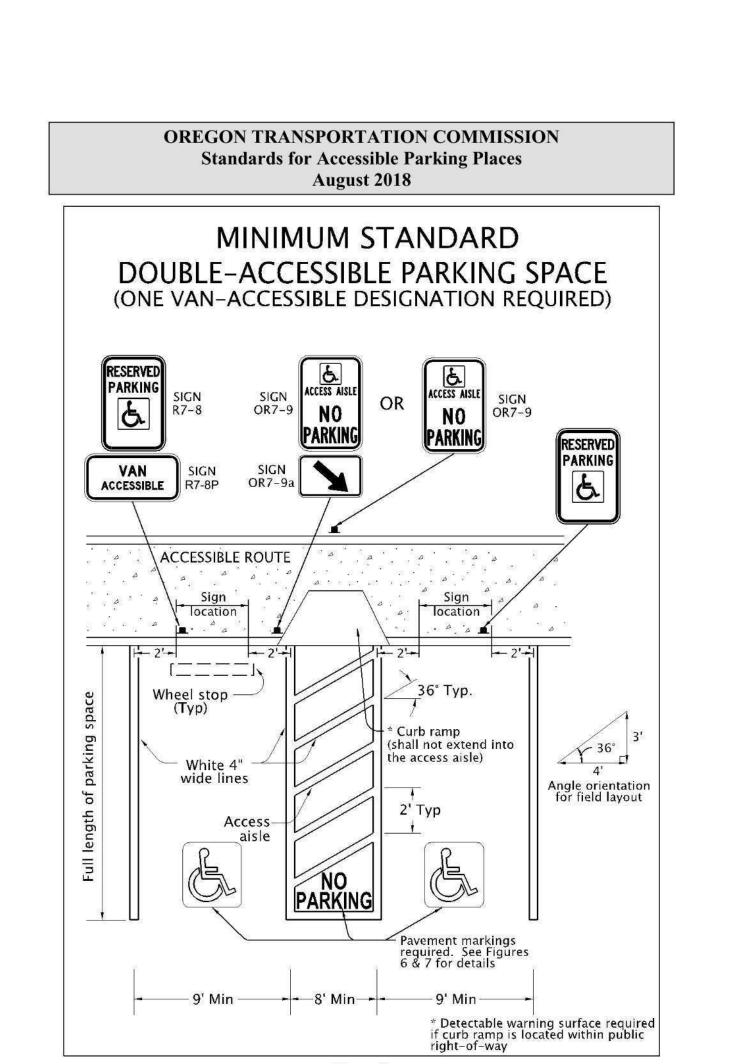
VAN ACCESSIBLE

wide lines

9' Min - 8' Min

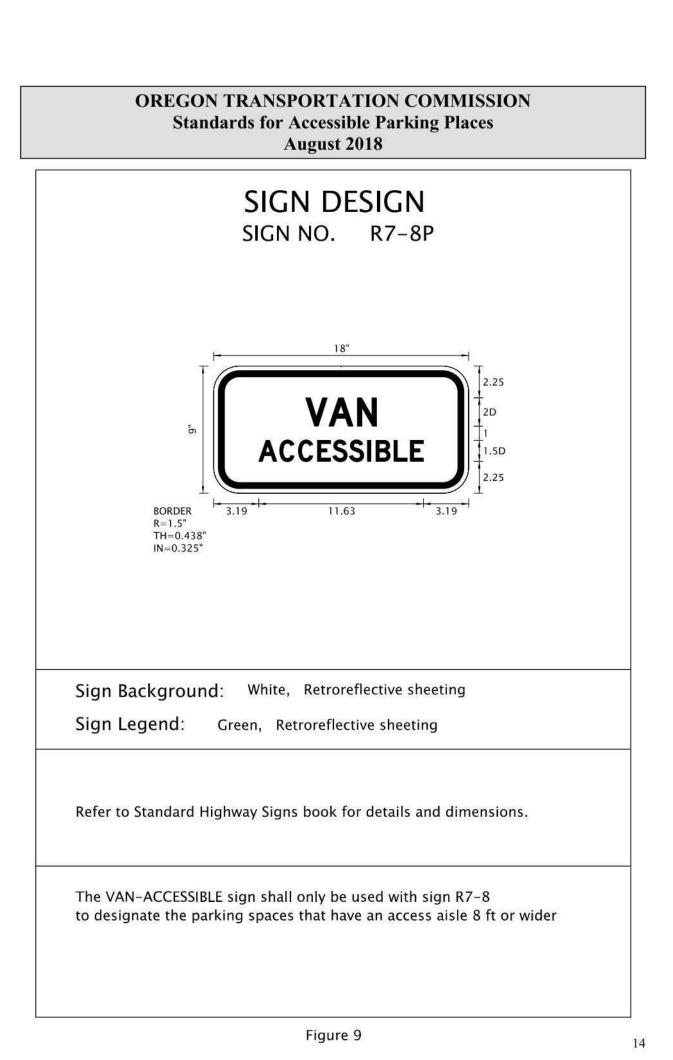



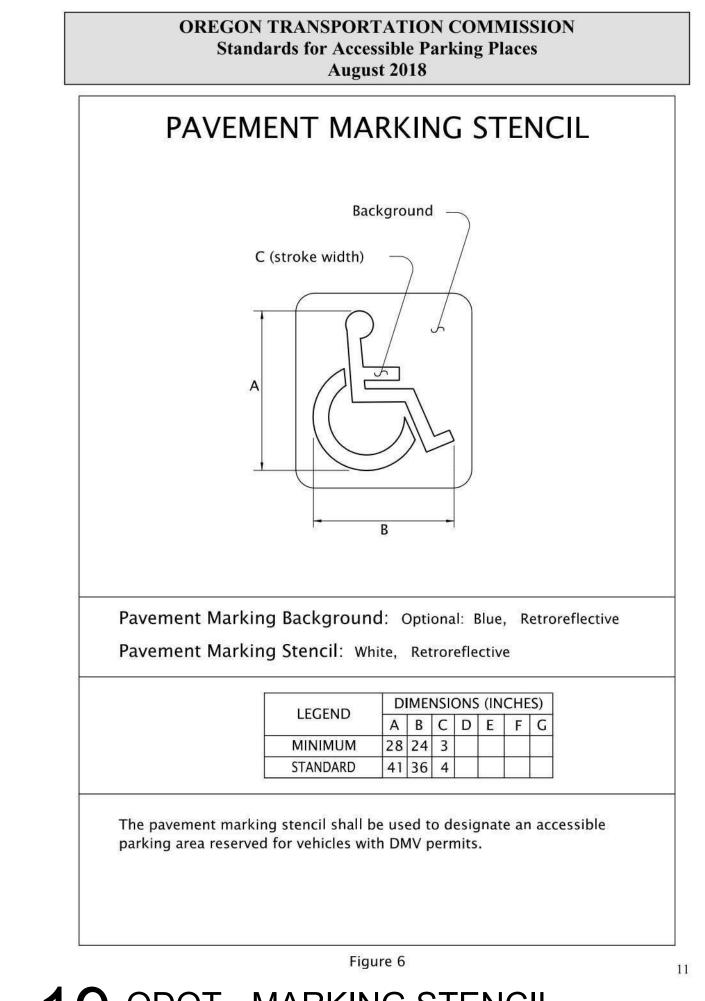

19 ODOT - MARKING STENCIL

Client/ Owner: GORDON TRUCK CENTERS

CLIENT ADDR

BUILDING **ADDITION**

5801 NE OLD SALEM MILLERSBURG, OR

SITE DETAILS


Sheet Title:

Revisions:

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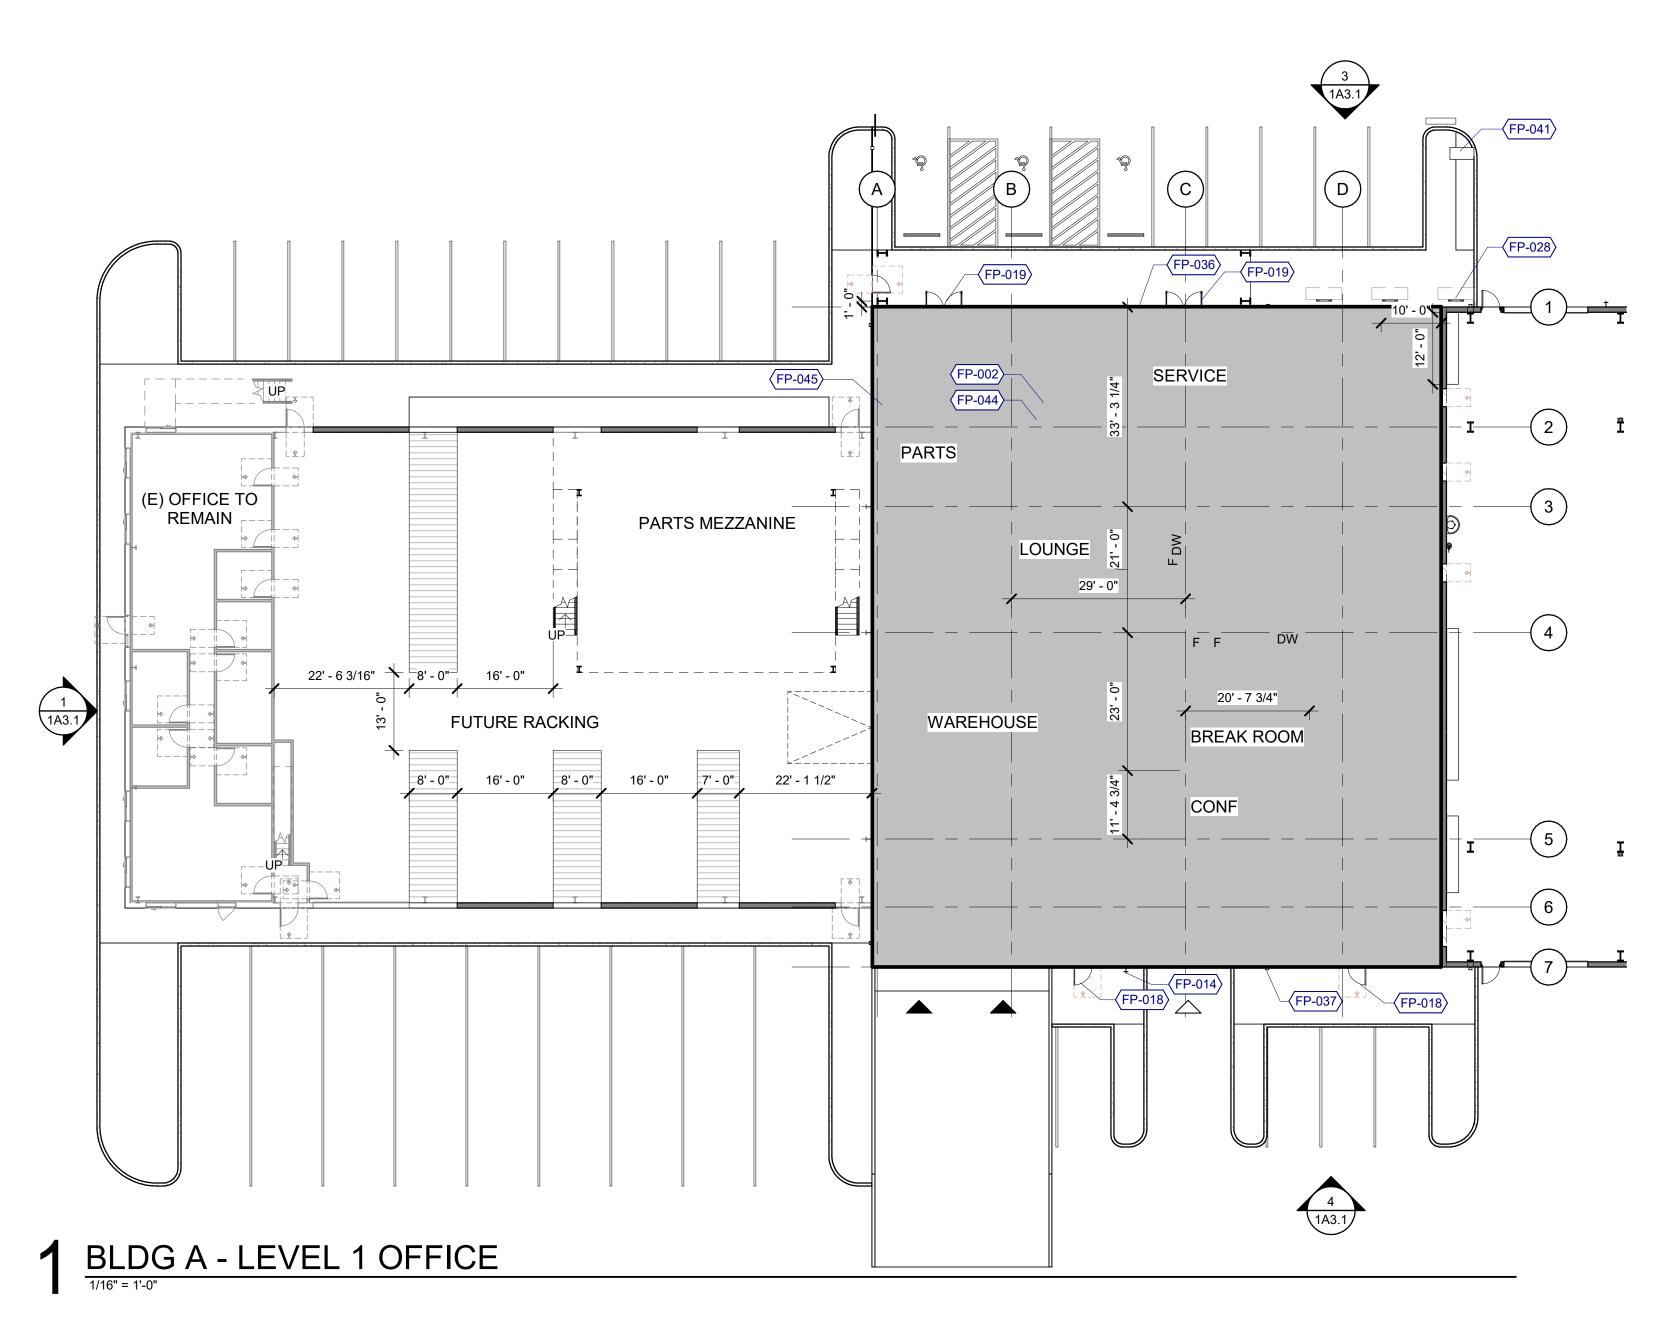
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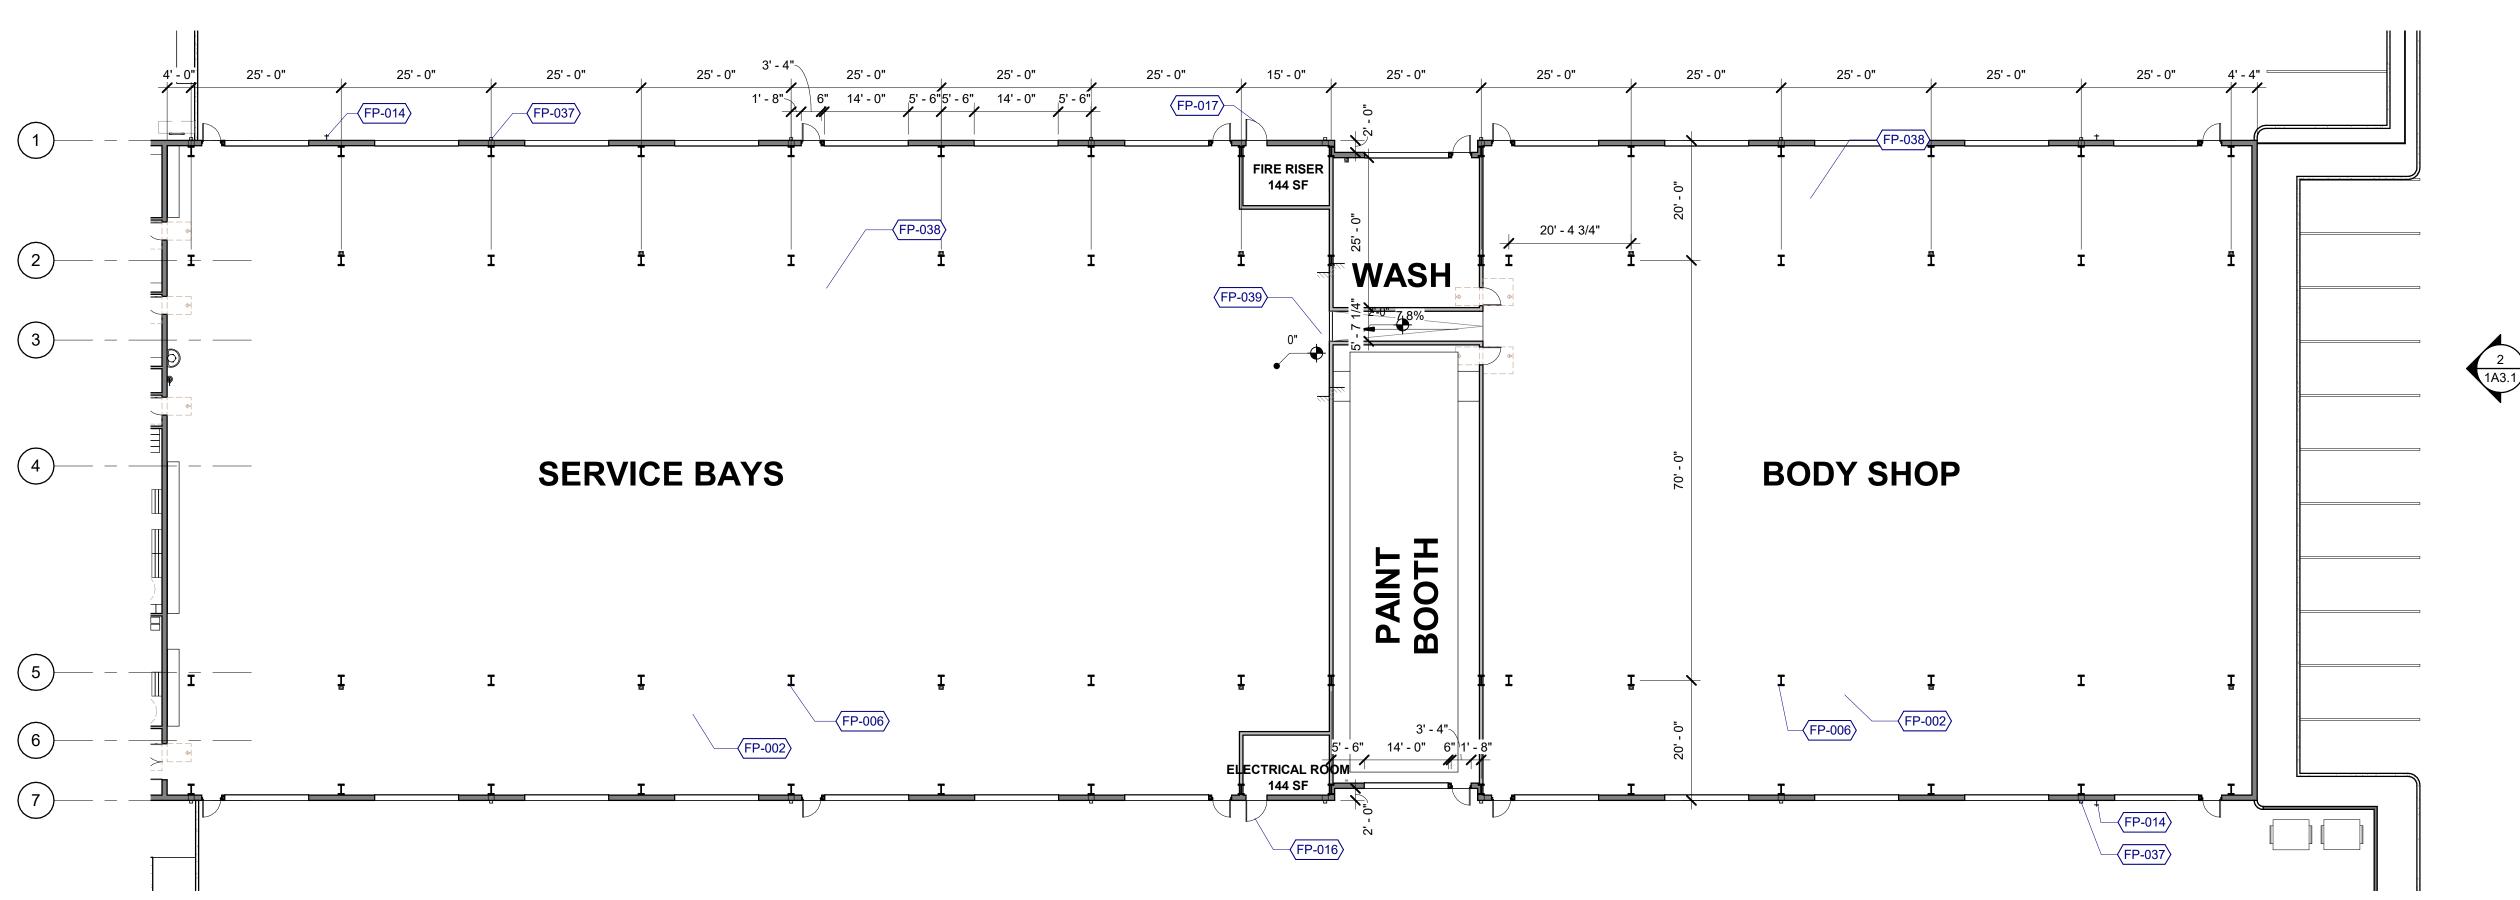
DESIGN REVIEW - JUNE 2023



6/20/2023

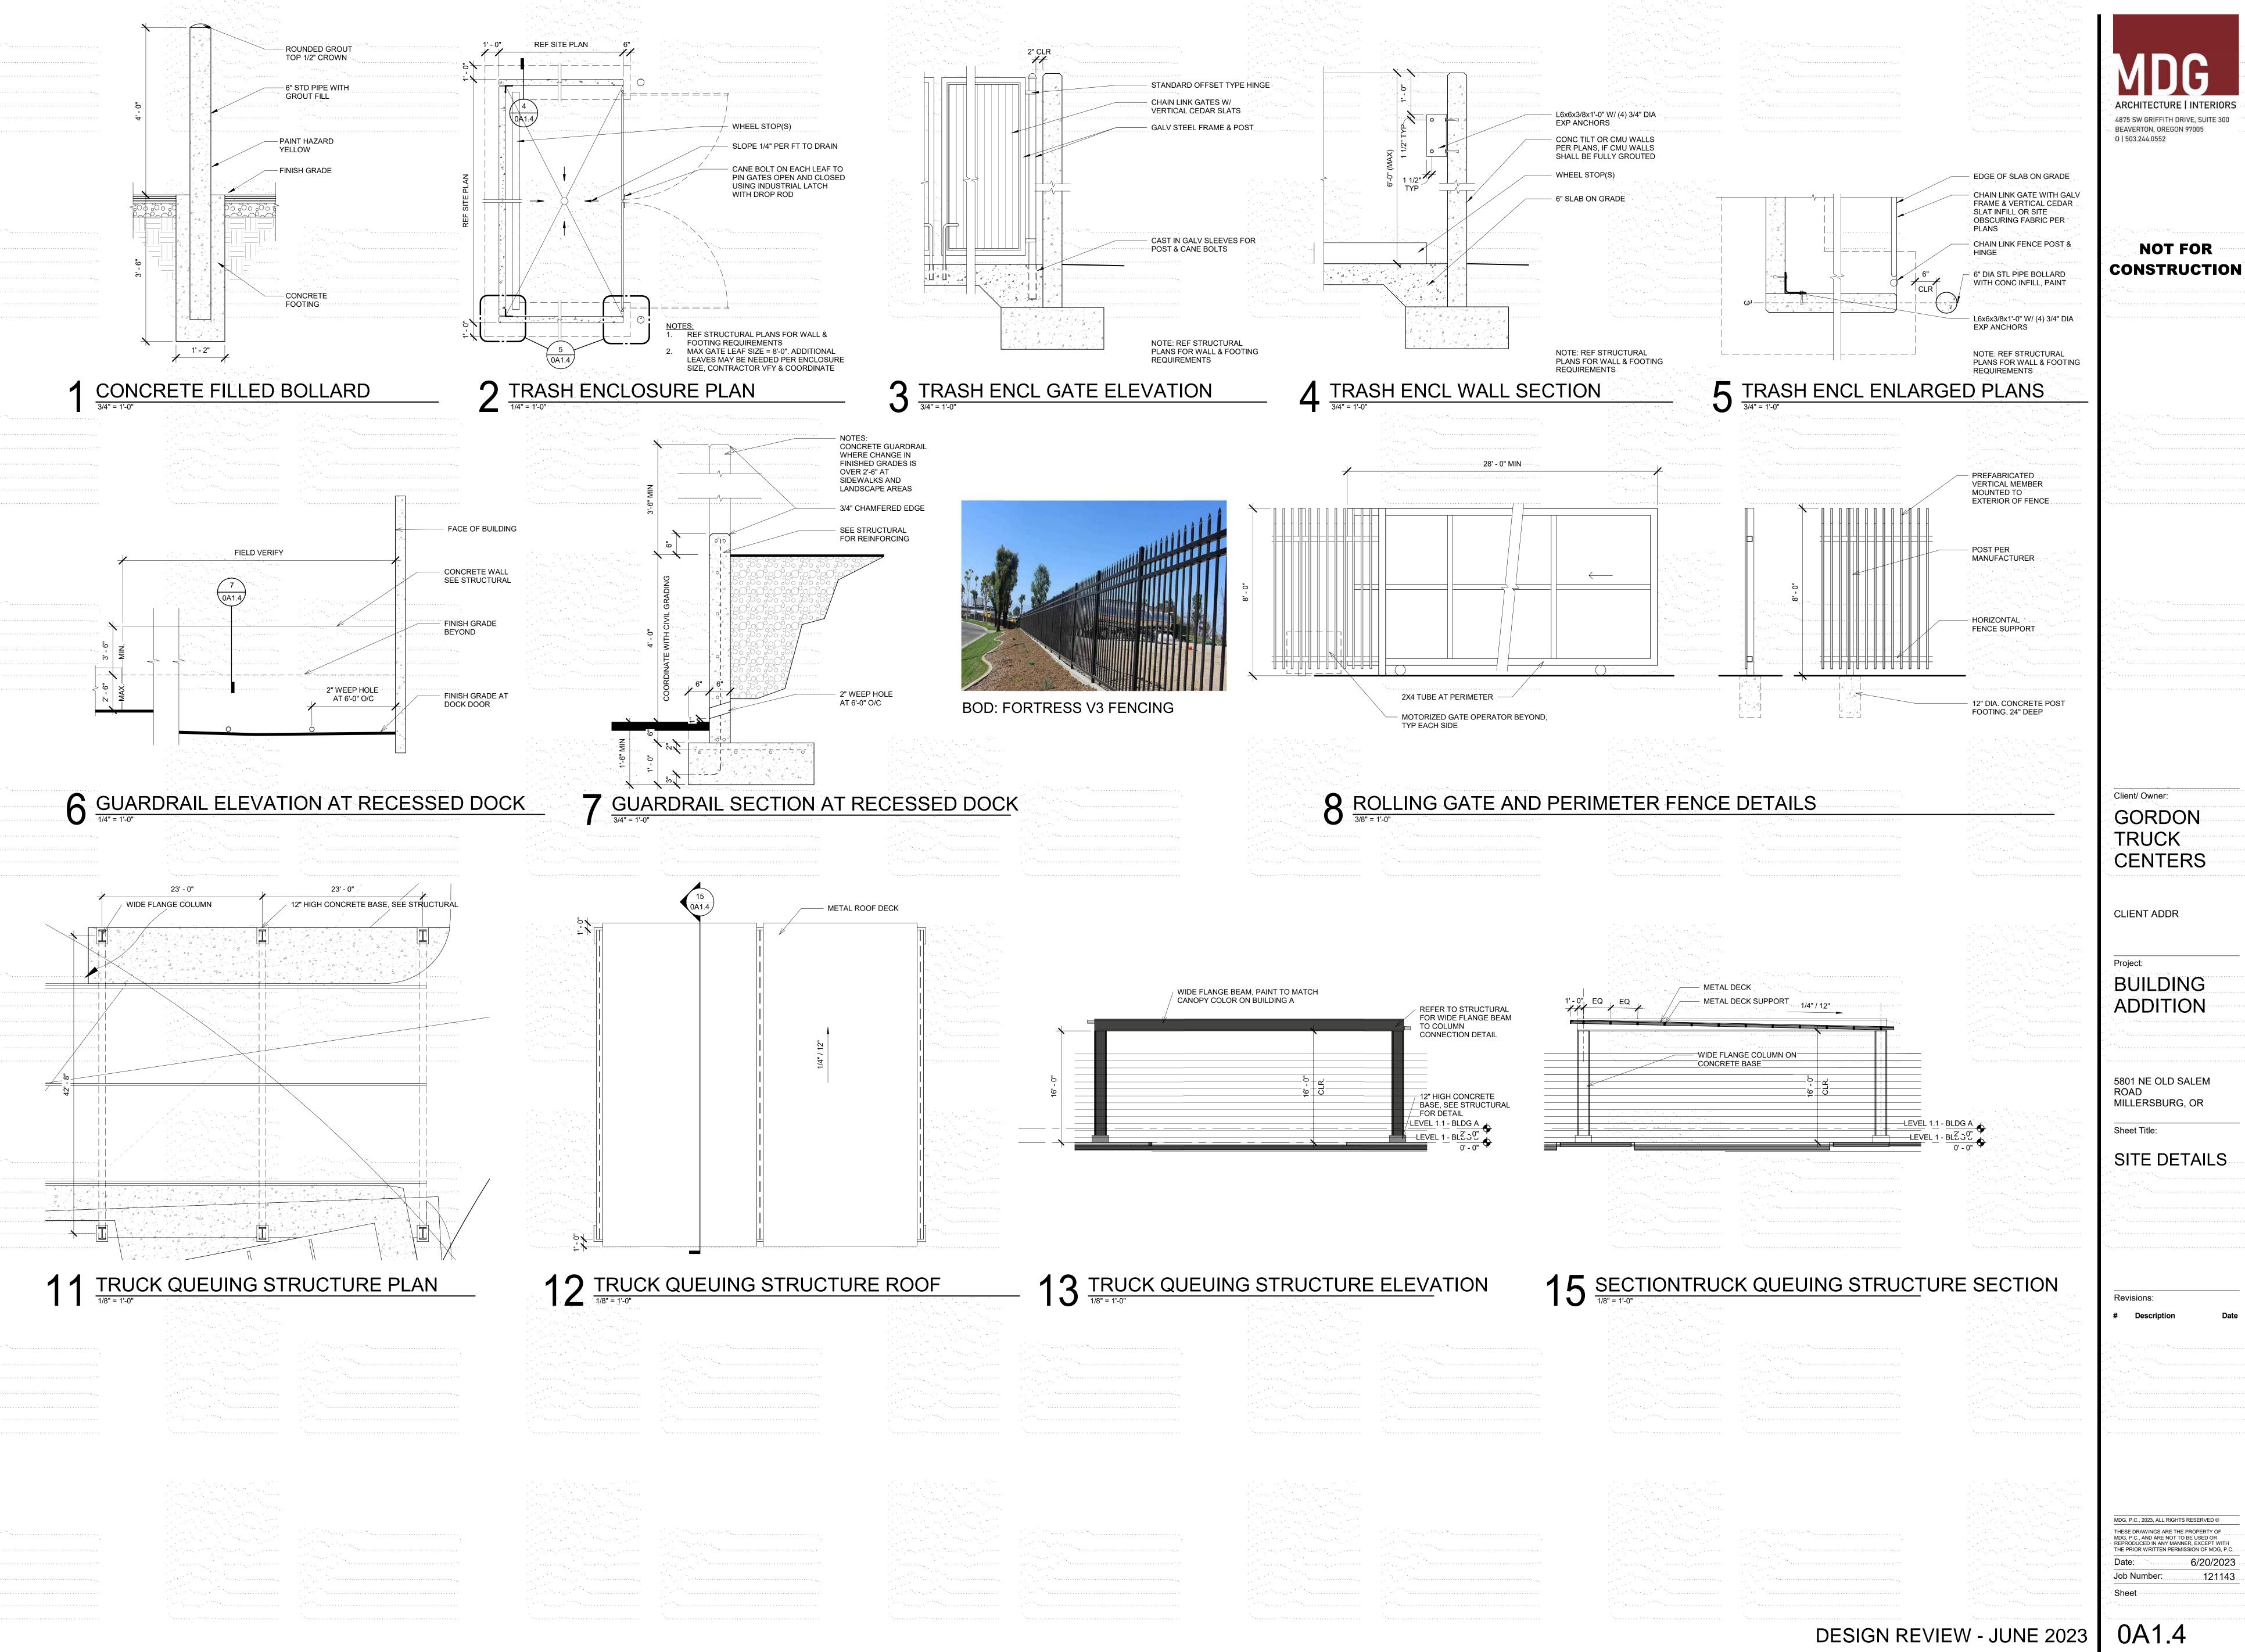121143





2 BLDG A - LEVEL 1 SERVICE

1/16" = 1'-0"

GENERAL NOTES - FLOOR PLANS

1. REFER TO SHEET G0.1 FOR 'PROJECT NOTES' APPLICABLE TO ALL PORTIONS OF THE WORK. PRIOR TO FRAMING GENERAL CONTRACTOR TO VERIFY PLUMBING, PIPES, CONDUIT, DUCTWORK, ELECTRICAL DEVICES, CASEWORK, FIXTURES, ETC. HAVE BEEN COORDINATED. UNCOORDINATED WALL SIZES SHALL BE REINSTALLED SOLEY AT CONTRACTOR'S EXPENSE.

3. SEE SHEETS G0.4 FOR WALL, FLOOR AND ROOF ASSEMBLIES. 4. SEE FIRE/LIFE SAFETY SHEETS BEGINNING ON A2.0 FOR LOCATIONS OF FIRE EXTINGUISHERS,

EXIT SIGNS, ETC. REFER TO STRUCTURAL DRAWINGS FOR COLUMNS, SHEAR WALL, BEAM SIZES AND SO ON. VERIFY AND COORDINATE SLAB PENETRATIONS INCLUDING SLEEVES & BLOCKOUTS AS

REQUIRED FOR PLUMBING, MECHANICAL, ELECTRICAL, ETC. NOTIFY ARCHITECT OF ANY

CONFLICTS OR DISCREPENCIES. 7. USE THE FOLLOWING DEFAULT ASSEMBLY TYPES UNLESS OTHERWISE NOTED ON THE DRAWINGS:

TYPE W1 / 8" CORE TYPE P1 / 3.5" CORE A. EXTERIOR WALLS INTERIOR PARTITIONS INTERIOR STAIR PARTITIONS TYPE P2 / 6" CORE

8. POWER & DATA OUTLETS INSTALLED 18" AFF, UNO. 9. PARTITIONS WITH SOLID FILL PATTERN DENOTE ACOUSTICALLY RATED, UNO. PROVIDE

ACOUSTICAL SEALANT, BATTS, PUTTY PADS, ETC. 10. FINISH NOTES: A. OFFICE AREAS - GYPSUM BOARD WALL SURFACES TO RECEIVE A LEVEL 4 FINISH, SMOOTH TEXTURE PER AWCI STANDARDS. APPLY A DRYWALL PRIMER (SHEETROCK BRAND "FIRST COAT" OR APPROVED) PRIOR TO FINAL FINISH COAT TO MINIMIZE SURFACE TEXTURE

B. WAREHOUSE AREAS - GYPSUM BOARD WALL SURFACES TO BE TAPED/ MUDDED ONLY,

KEYNOTES

FP-014

CONCRETE SLAB ON GRADE OVER GRAVEL BASE - SEE STRUCTURAL

FP-006 STEEL COLUMN, PAINTED - SEE STRUCTURAL

FP-016 'ELECTRICAL ROOM' SIGNAGE AT EXTERIOR DOOR

FP-017 'FIRE RISER ROOM' SIGNAGE AT EXTERIOR DOOR FP-018 PEDESTRIAN DOOR, HOLLOW METAL

FP-019 STOREFRONT SYSTEM, THERMALLY INSULATED FP-028 BIKE RACK EXTERIOR

FP-036 KNOX BOX, COORDINATE FINAL LOCATION(S) WITH FIRE MARSHAL

FP-037 SCUPPER AND DOWNSPOUT

FP-038 FUTURE BRIDGE CRANE

HOSE BIBB

FP-039 FOUNDATION STEP FP-041 MAILBOX LOCATION, VERIFY LOCATION WITH USPS

FP-044 VAPOR RETARDER AT PROPOSED OFFICE PERIMETER SLAB INSULATION WHERE INDICATED ON PLANS FP-045

4875 SW GRIFFITH DRIVE, SUITE 300 BEAVERTON, OREGON 97005 0 | 503.244.0552

NOT FOR CONSTRUCTION

Client/ Owner:

GORDON TRUCK CENTERS

CLIENT ADDR

BUILDING **ADDITION**

5801 NE OLD SALEM ROAD MILLERSBURG, OR

Sheet Title:

FLOOR PLAN, **OVERALL BLDG**

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121143

DESIGN REVIEW - JUNE 2023

LEGEND	
	SKYLIGHT

SKYLIGHT AREA CALCULATIONS

<u>SERVICE/ PARTS</u> SKYLIGHT SIZE/ QUANTITY: DAYLIGHT AREA UNDER SKYLIGHT BUILDING AREA / DAYLIGHT AREA

.7 x 28 FT CEILING HEIGHT = 19.6' = 39' EACH WAY (EW) (4'W + 39' EW = 43'W) x (8'L + 39' EW = 47'L) = 2,021 SF 5,616 SF*50% = 2,808 / 2,021 SF = 1.39 SKYLIGHTS, MIN (4) PROVIDED > 2, OKAY

<u>SERVICE BAYS</u> SKYLIGHT SIZE/ QUANTITY: DAYLIGHT AREA UNDER SKYLIGHT .7 x 20 FT CEILING HEIGHT = 14' = 28' EACH WAY (EW) (4'W + 28' EW = 32'W) x (8'L + 28' EW = 36'L) = 1,152 SF BUILDING AREA / DAYLIGHT ARÉA ` 38,316 SF*50% = 19,158 / 1,152 SF = 16.6 SKYLIGHTS, MIN

DOWNSPOUT CALCULATIONS

PRELIMINARY CALCULATIONS - PLUMBING CONTRACTOR TO VERIFY PER OPSC TABLE 1103.1 ESTIMATED RAIN FALL PER TABLE D 101.1 = 1.3 IN/HOUR

(18) PROVIDED > 17, OKAY

(4) PROVIDED > 1, OKÁY

SERVICE/ PARTS ROOF AREA = 7,884 SF 7,884 / 9,200 SF = (0.87) 4" DOWNSPOUTS REQUIRED

<u>SERVICE BAYS</u> ROOF AREA = 42,000 SF 42,000 / 9,200 SF = (4.57) 4" DOWNSPOUTS REQUIRED (16) PROVIDED > 5, OKÁY

GENERAL NOTES - ROOF PLANS

- REFER TO SHEET G0.1 FOR 'PROJECT NOTES' APPLICABLE TO ALL PORTIONS OF THE WORK.
 PROVIDE ROOFING MANUFACTURER'S STANDARD WALKWAY PADS BETWEEN ALL ROOF HATCHES, ROOF ACCESS DOORS, AND ROOFTOP EQUIPMENT AND AROUND PERIMETER OF ALL ROOFTOP
- PROVIDE POSITIVE ROOF SLOPE TO DRAIN AT MINIMUM SLOPE OF 1/4" PER FOOT, UNO.
 ROOF PENETRATIONS SHOWN ARE SCHEMATIC IN NATURE; COORDINATE ACTUAL SIZE, TYPE AND
- LOCATION OF EQUIPMENT. CURBS, AND ANY OTHER ROOF PENETRATIONS THAT MAY BE REQUIRED TO SUPPORT, SECURE OR FLASH ROOFTOP EQUIPMENT. COMPLY WITH THE MOST STRINGENT OF SMACNA, NRCA OR MANUFACTURERS' REQUIREMENTS
- FOR FLASHINGS, COPINGS, SCUPPERS AND OTHER SHEET METAL CONSTRUCTION. 6. VERIFY ROOFING MANUFACTURER'S MINIMUM REQUIREMENTS FOR LAPPING OF ALL MATERIALS. BRING CONFLICTS WITH ARCHITECTURAL DETAILS TO THE ATTENTION OF THE ARCHITECT PRIOR
- TO INSTALLATION. 7. SKYLIGHT/ SMOKE AND HEAT VENT CURBS R-5 MIN, UNLESS INCLUDED AS A COMPONENT OF
- SKYLIGHT LISTED AND LABELED IN ACCORDANCE WITH NFRC 100. MECHANICAL CURBS R-13, MIN.

LOCATE ROOFTOP MECHANICAL EQUIPMENT 10'-0" MIN FROM INSIDE F.O. PARAPET/ ROOF EDGE SO GUARDRAIL NOT REQUIRED.

KEYNOTES

RP-001 STEEL CANOPY BELOW

RP-003 GUTTER AND DOWNSPOUT

RP-005 RIDGE

RP-007 CRICKET RP-012 SKYLIGHT, CRICKET ON HIGH SIDE

DOWNSPOUT LOCATION 12' - 6" 21' - 3 1/4" 50' - 0" 50' - 0" 39' - 0" 3 (VERIFY) 4 3" / 12" 3" / 12" <u>BUILDING A-</u> ADDITION, LOWER ROOF BUILDING A-ADDITION, UPPER ROOF (VERIFY) 5 (RP-003) 29' - 0"

1 ROOF - BLDG A

4875 SW GRIFFITH DRIVE, SUITE 300 BEAVERTON, OREGON 97005 0 | 503.244.0552

NOT FOR CONSTRUCTION

Client/ Owner:

GORDON TRUCK CENTERS

CLIENT ADDR

BUILDING **ADDITION**

5801 NE OLD SALEM ROAD MILLERSBURG, OR

ROOF PLAN BLDG A

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GENERAL NOTES - EXTERIOR ELEVATIONS


- REFER TO SHEET G0.1 FOR 'PROJECT NOTES' APPLICABLE TO ALL PORTIONS OF THE WORK.
- REFER TO SHEET GU. FOR PROJECT NOTES APPLICABLE TO ALL PORTIONS
 ELEVATIONS NOTED ARE RELATIVE TO PROJECT DATUM.
 REFER TO SHEET G0.4 FOR VERTICAL AND HORIZONTAL ASSEMBLY TYPES.
 CONTRACTOR TO VERIFY SAFETY GLAZING REQUIREMENTS & LOCATIONS.
 EXTERIOR GLAZING TYPE GL-X, UNO.
 BUILDING ADDRESS SIGNAGE...(ZONING).

KEYNOTES


MATERIALS SCHEDULE (REFER TO 1A3.2)



NOT FOR CONSTRUCTION

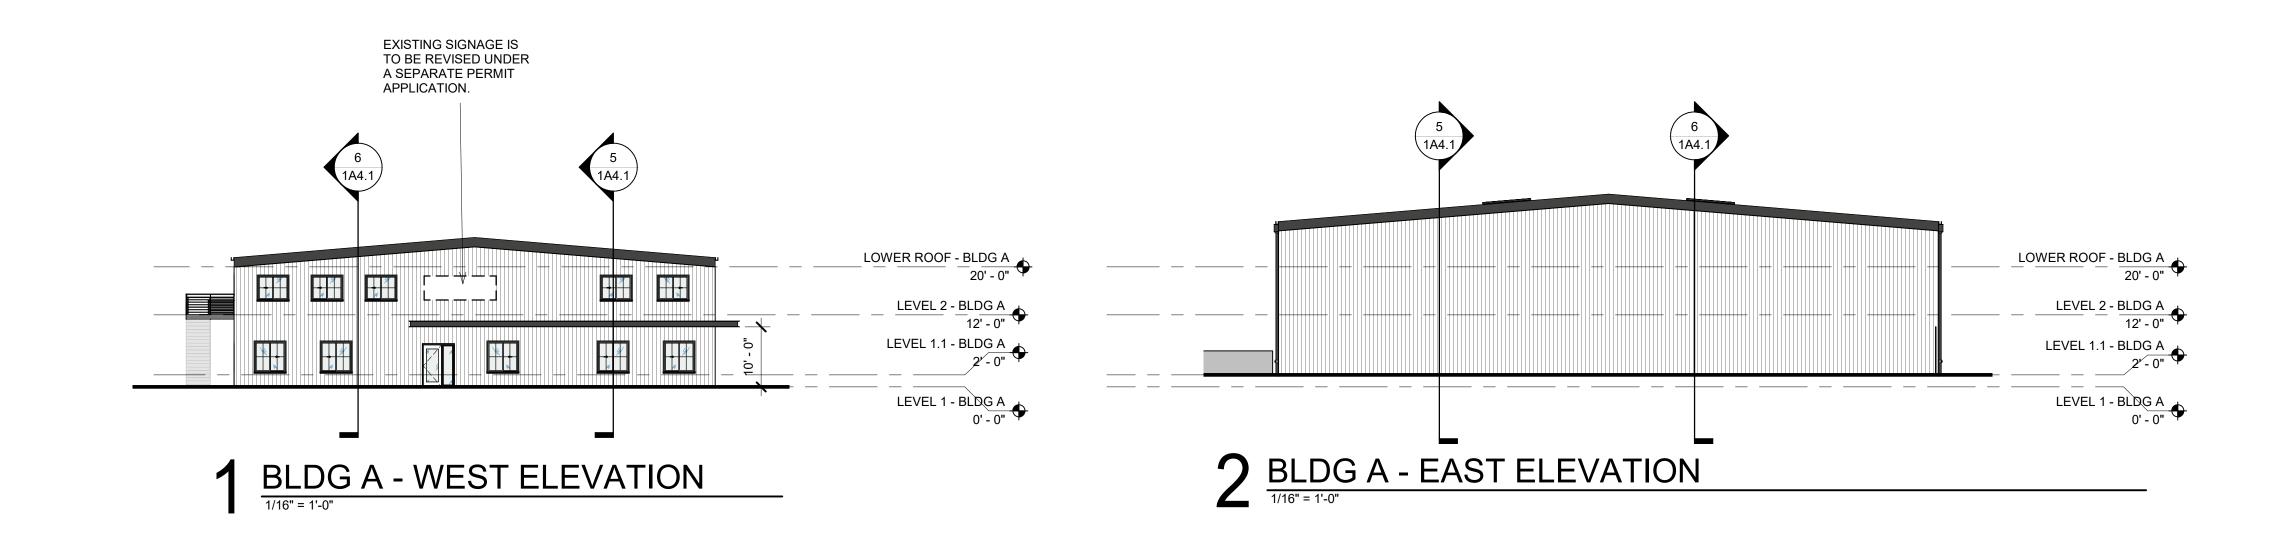



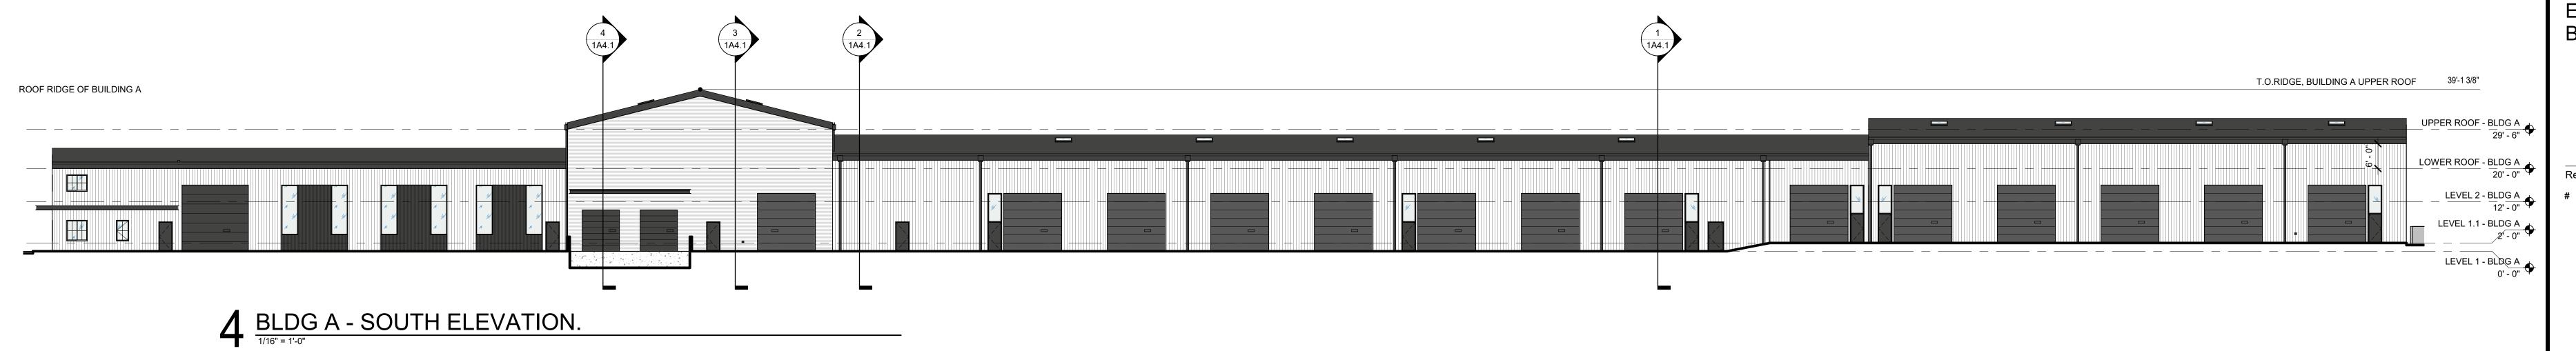

5801 NE OLD SALEM ROAD MILLERSBURG, OR **ELEVATIONS** BLDG A

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EXTERIOR LIGHTING

Lithonia Lighting
Pole Mounted Site Fixture
DSX0 LED: P1, P2, P3, SM1, SM2,
Finish: TBD



Gotham Round Downlight 4" EV04: R-1



Bega LED Wall Luminaires 33 514, Finish: TBD



Bega LED Wall Luminaires SM-3, Finish: TBD



ALUMINUM
Recognized as the industry's first choice for its exceptional durability. Heavy-duty extruded aluminum.

PRIMER COAT
Specially formulated primer coat assures optimal adhesion between aluminum and ink.

High-definition digital inkjet prints of a wide range of textures with outstanding color variations.

2-CLEAR**
A protective clear coat is applied to provide long-term protection against fading.

Mustration shows 129-01 CAMARY WOOD - Natural

AVAILABLE SIZES

Standard thickness
Standard length
8* [2.4m] [12* [3.7m] [16* [4.9m]
Standard width*
2* [Simm] 3* [76mm] 4* [102mm]
5* [127mm] [6* [152mm] 8* [203mm]
*Nominal dimensions, see technical data sheet for actual state.

Other width dimensions are available, upon request.

Mustration shows 101-01 CUMARU - Variegated Light


1* 1W* 2* [Simm]
[Standard Light]

1* 1W* 2* [Simm]

ALUMINIUM TRELLIS
MFR: DIZAL
SIZE:2" X 6", 5" O.C. END MOUNT
FINISH: 124-02 BURMA TEAK BLOND
ALUMINIUM SOFFIT CEILING
PROFILE: 6" PLANK V GROOVE PROFILE
FINISH: 124-02 BURMA TEAK BLOND



PT-3 (HM & OH DOORS, CANOPY, FLASHING) SW 7069 IRON ORE

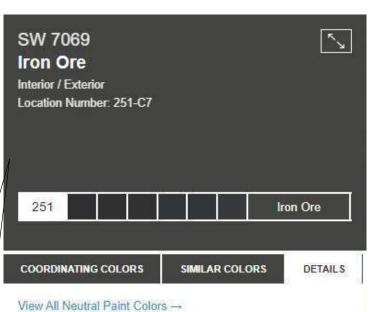

View All Neutral Paint Colors →
R:67 G:67 B:65 Hex Value:#434341 LRV:6

MATERIAL BOARD

BUILDING ELEMENT

EXTERIOR WALLS
STOREFRONT
GLAZING
DOORS
DOORS
DOORS
CANOPY
CANOPY SOFFIT
FLASHING

<u>MATERIAL</u>

METAL CLADDING
ALUMINIUM
GLASS
ALUMINIUM
HOLLOW METAL
OVERHEAD
STEEL TUBE AND / OR CHANNEL
WOOD
METAL

<u>FINISH</u>

SEE LEGEND ANODIZED, DARK BRONZE CLEAR ANODIZED, DARK BRONZE PAINT, SW 7069 IRON ORE PAINT, SW 7069 IRON ORE PAINT, SW 7069 IRON ORE CLEAR PAINT, SW 7069 IRON ORE

TEXTURE/ SHEEN

MFR
SMOOTH
SMOOTH
SMOOTH/SATIN
SMOOTH/SATIN
SMOOTH/SATIN
SMOOTH/SATIN
SMOOTH/SATIN

COLOR

<u>PT-1</u> (MAIN BODY METAL COLOR) REGAL WHITE

Cool REGAL WHITE

SRI: 88 • LRV: 75


<u>PT-2</u> (ACCENT PANEL AND ROOF COLOR) MIDNIGHT BRONZE



Cool MIDNIGHT BRONZE

SRI: 27 • LRV: 7

METAL PANEL (AEP SPAN FLEX SERIES)
HORIZONTAL & VERTICAL STAGGERED
2", 4", & 6" PATTERN

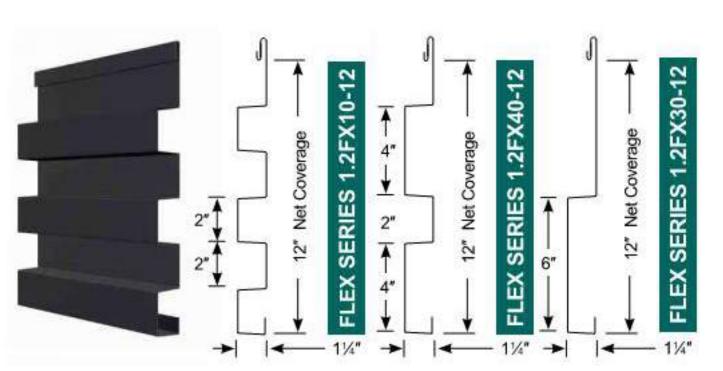

METAL PANEL (AEP SPAN FLEX SERIES) VERTICAL 10" PATTERN



METAL ROOF
MFR: AEP SPAN
STYLE: SPANSEAM METAL ROOFING, 22 GA
COLOR: MIDNIGHT BRONZE



ARCHITECTURE | INTERIORS

4875 SW GRIFFITH DRIVE, SUITE 300
BEAVERTON, OREGON 97005
0 | 503.244.0552

NOT FOR CONSTRUCTION

Client/ Owner:

GORDON TRUCK CENTERS

CLIENT ADDR

Project:
BUILDING
ADDITION

5801 NE OLD SALEM ROAD MILLERSBURG, OR

Sheet Title:

EXTERIOR MATERIALS BLDG A

Revisions:


Description

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Date: 6/20/2023

Job Number: 121143



6 BLDG A_ SECTION THROUGH EXISTING AND ADDITION
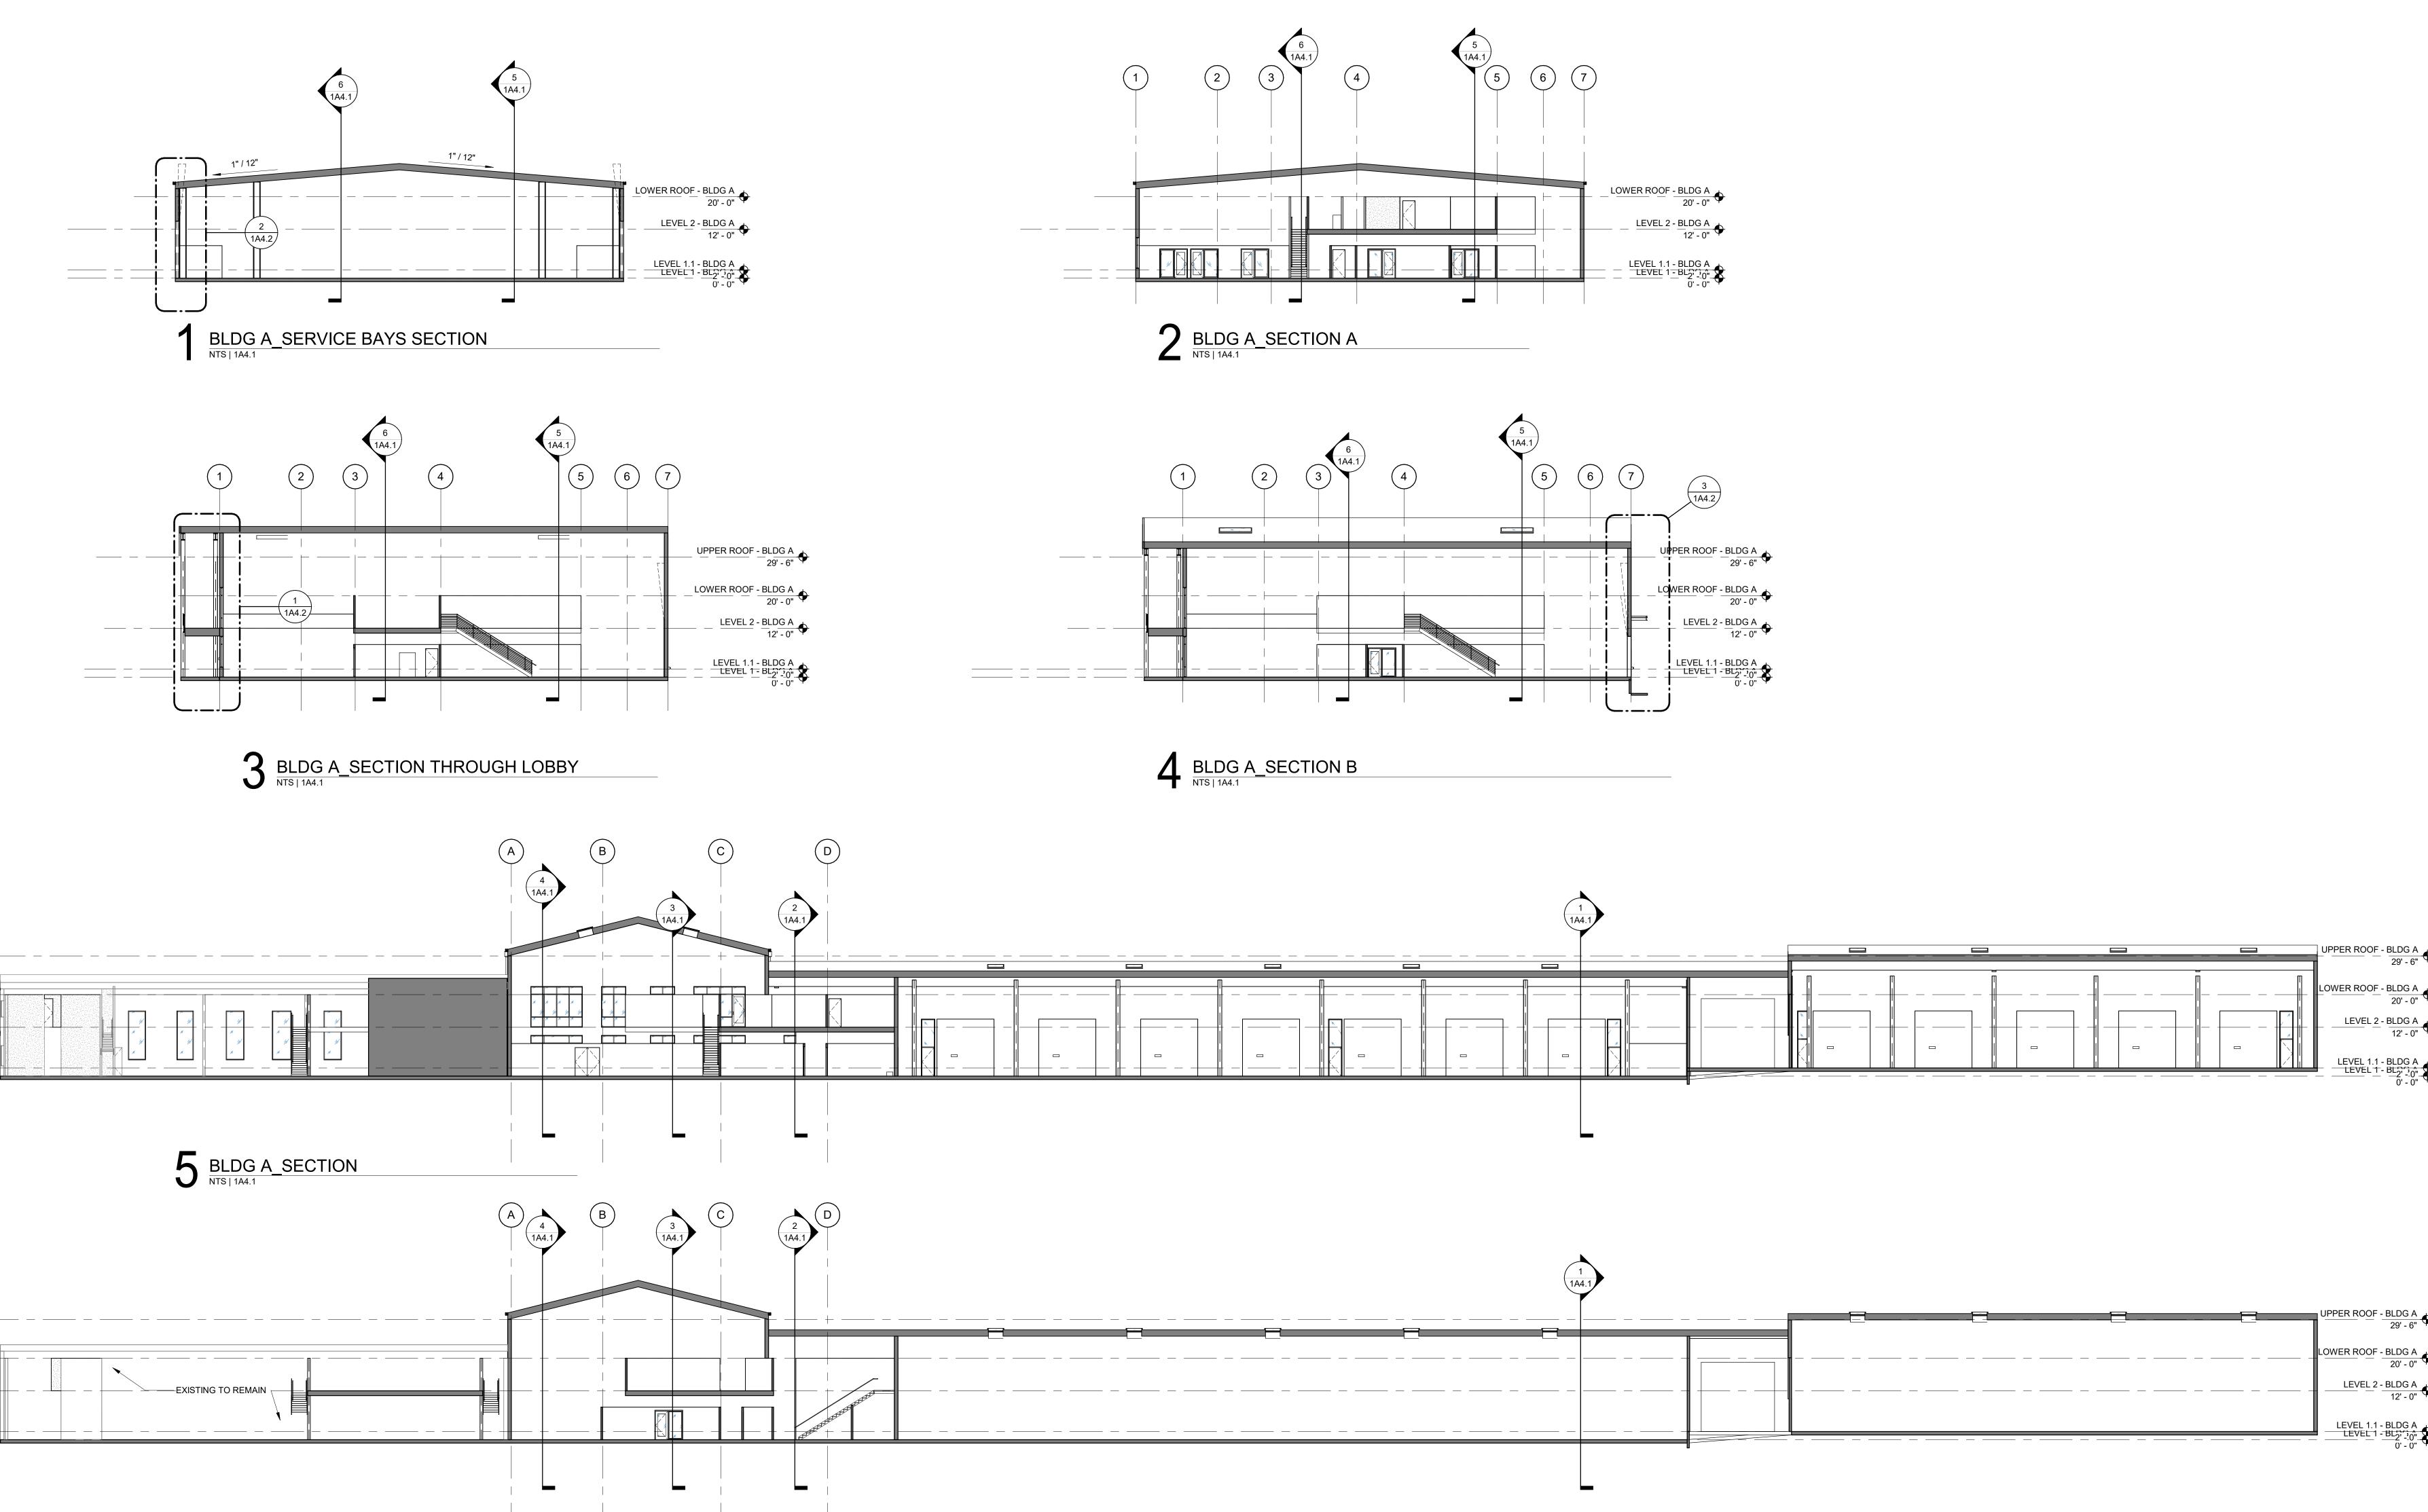
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6/20/2023 121143

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 REFER TO SHEET G0.4 FOR VERTICAL AND HORIZONTAL ASSEMBLY TYPES.

KEYNOTES

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NOT FOR CONSTRUCTION

GORDON TRUCK CENTERS

CLIENT ADDR

BUILDING ADDITION


5801 NE OLD SALEM ROAD MILLERSBURG, OR


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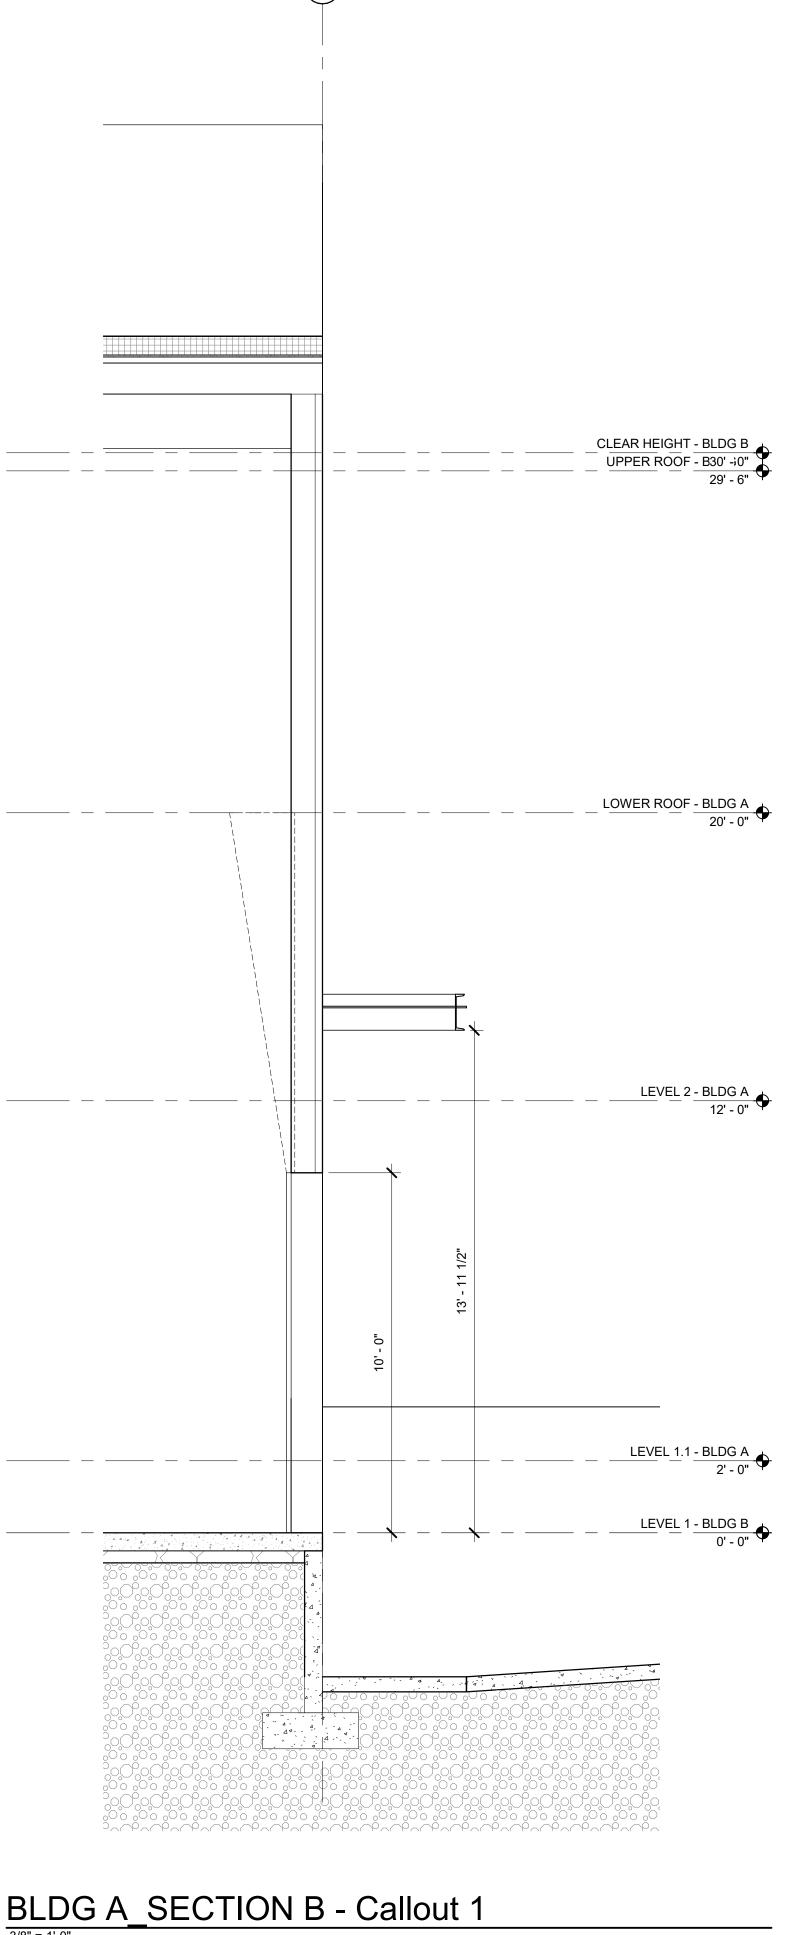
WALL SECTIONS BLDG A

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DESIGN REVIEW - JUNE 2023





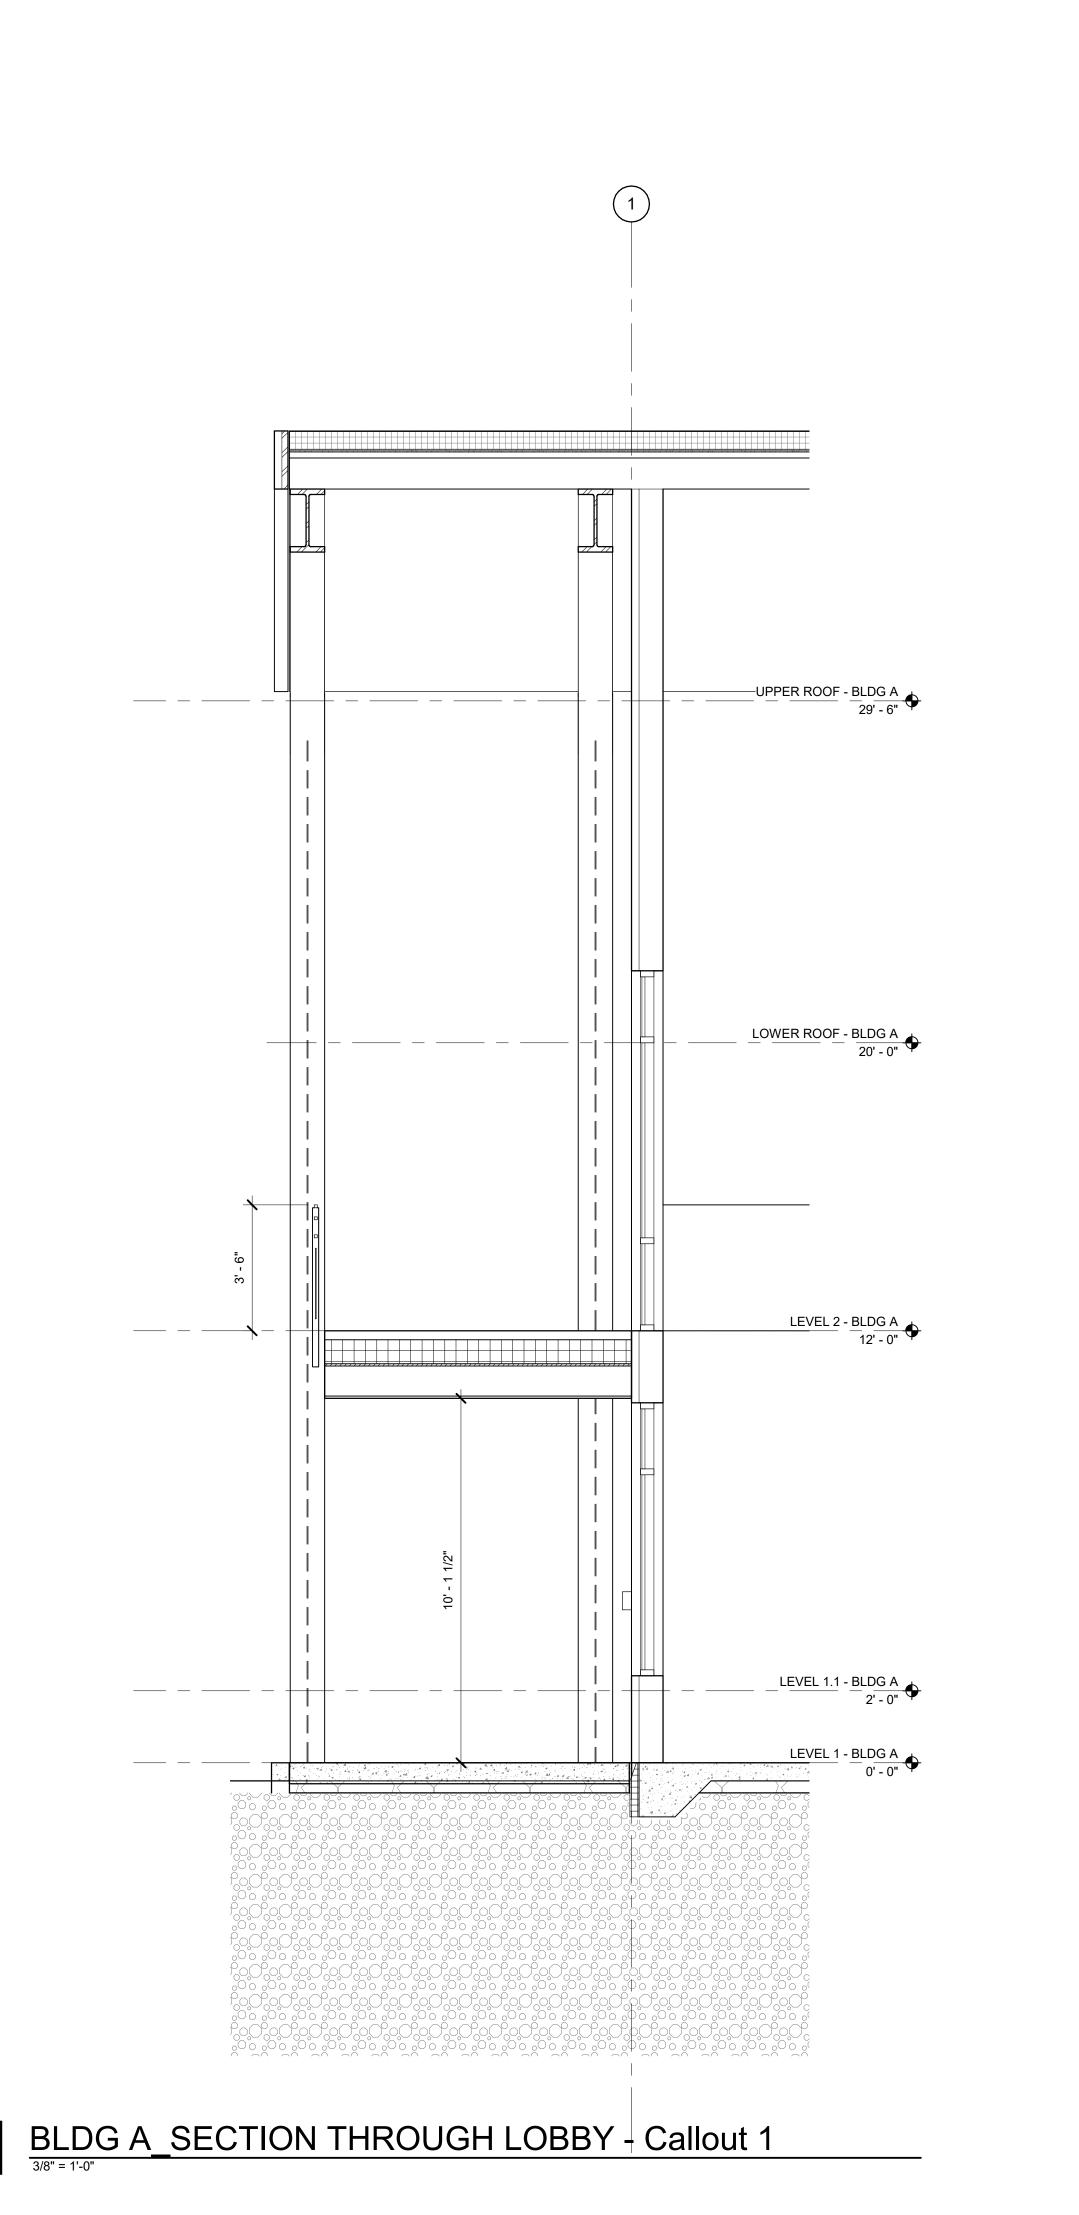

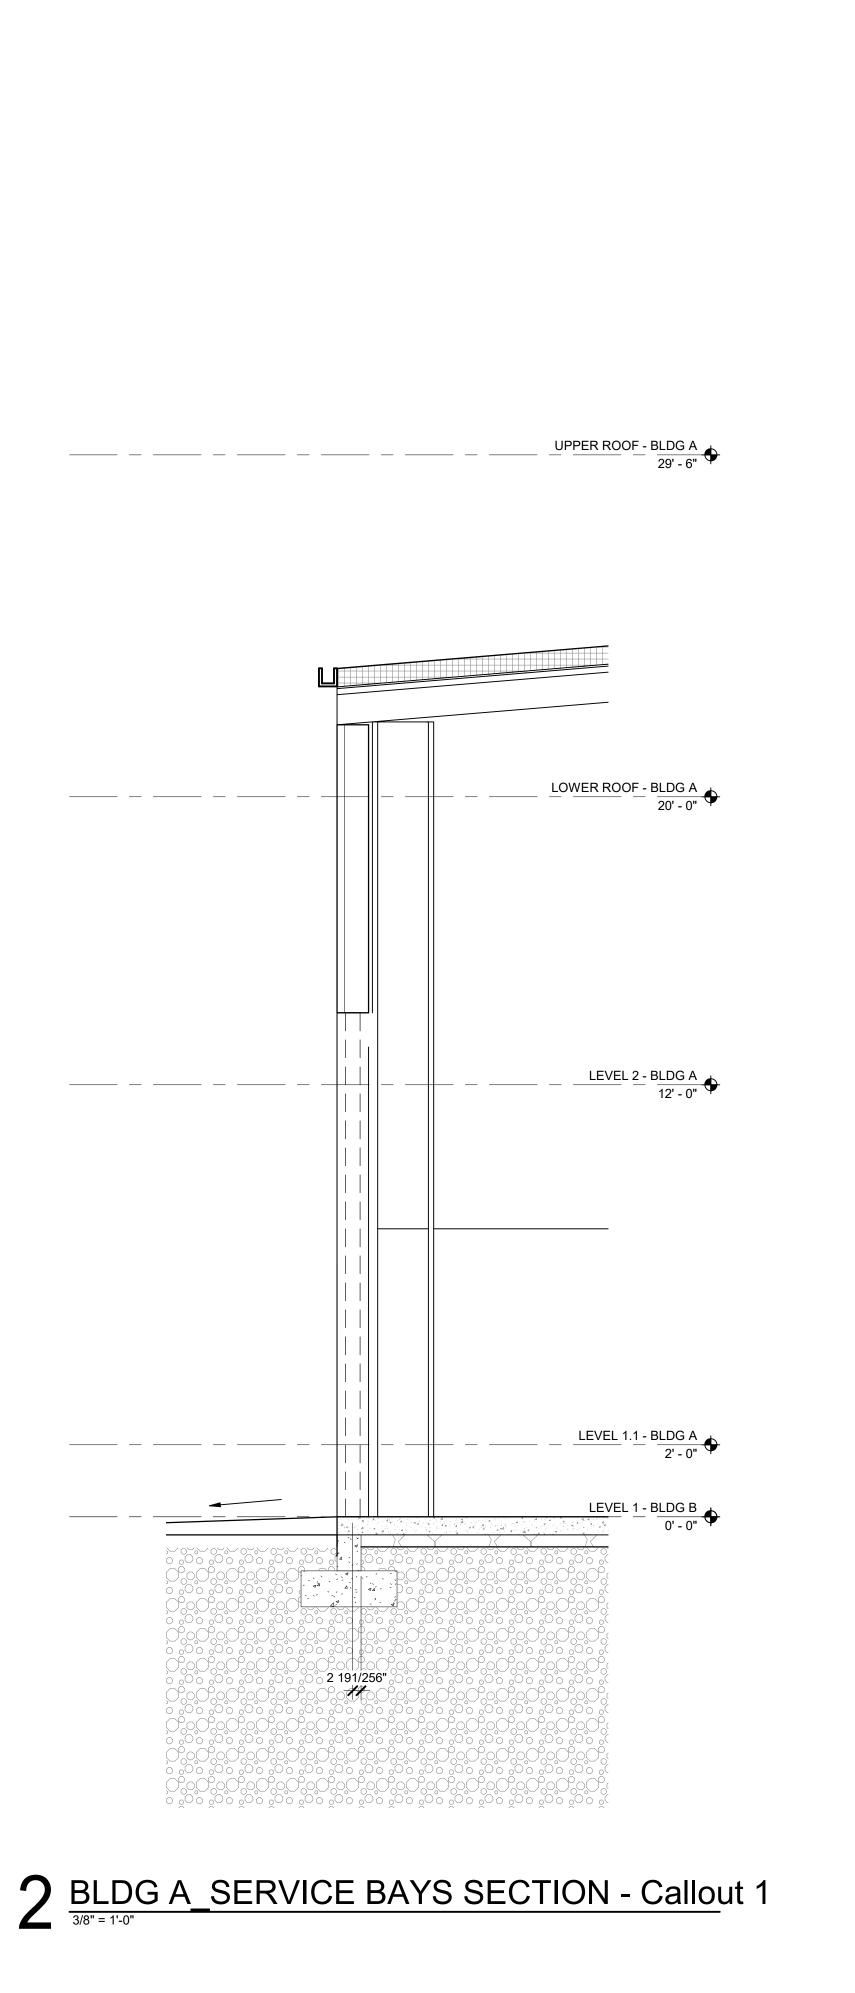GENERAL NOTES - FLOOR PLANS

- 1. REFER TO SHEET G0.1 FOR 'PROJECT NOTES' APPLICABLE TO ALL PORTIONS OF THE WORK. 2. PRIOR TO FRAMING GENERAL CONTRACTOR TO VERIFY PLUMBING, PIPES, CONDUIT, DUCTWORK, ELECTRICAL DEVICES, CASEWORK, FIXTURES, ETC. HAVE BEEN COORDINATED. UNCOORDINATED WALL SIZES SHALL BE REINSTALLED SOLEY AT CONTRACTOR'S EXPENSE.
- 3. SEE SHEETS G0.4 FOR WALL, FLOOR AND ROOF ASSEMBLIES. 4. SEE FIRE/LIFE SAFETY SHEETS BEGINNING ON A2.0 FOR LOCATIONS OF FIRE EXTINGUISHERS,
- EXIT SIGNS, ETC. 5. REFER TO STRUCTURAL DRAWINGS FOR COLUMNS, SHEAR WALL, BEAM SIZES AND SO ON.
 6. VERIFY AND COORDINATE SLAB PENETRATIONS INCLUDING SLEEVES & BLOCKOUTS AS
- REQUIRED FOR PLUMBING, MECHANICAL, ELECTRICAL, ETC. NOTIFY ARCHITECT OF ANY CONFLICTS OR DISCREPENCIES.
- 7. USE THE FOLLOWING DEFAULT ASSEMBLY TYPES UNLESS OTHERWISE NOTED ON THE DRAWINGS: TYPE W1 / 8" CORE EXTERIOR WALLS
- INTERIOR PARTITIONS TYPE P1 / 3.5" CORE INTERIOR STAIR PARTITIONS TYPE P2 / 6" CORE

54' - 0"

27' - 0"____

-58' - 0"

15' - 4" 9' - 2"

(FP-014)

F

LEVEL 1 - BLDG B

(FP-028)

(A) + + +

29' - 0"

- POWER & DATA OUTLETS INSTALLED 18" AFF, UNO. 9. PARTITIONS WITH SOLID FILL PATTERN DENOTE ACOUSTICALLY RATED, UNO. PROVIDE ACOUSTICAL SEALANT, BATTS, PUTTY PADS, ETC.
- 10. FINISH NOTES: A. OFFICE AREAS - GYPSUM BOARD WALL SURFACES TO RECEIVE A LEVEL 4 FINISH, SMOOTH TEXTURE PER AWCI STANDARDS. APPLY A DRYWALL PRIMER (SHEETROCK BRAND "FIRST" COAT" OR APPROVED) PRIOR TO FINAL FINISH COAT TO MINIMIZE SURFACE TEXTURE
- B. WAREHOUSE AREAS GYPSUM BOARD WALL SURFACES TO BE TAPED/ MUDDED ONLY,

54' - 0"

27' - 0"

27' - 0"

KEYNOTES

- FP-001 CONCRETE WALL, TILT-UP FP-006 STEEL COLUMN, PAINTED - SEE STRUCTURAL
- FP-012 LADDER, ROOF ACCESS FP-014 HOSE BIBB
- FP-018 PEDESTRIAN DOOR, HOLLOW METAL FP-019 STOREFRONT SYSTEM, THERMALLY INSULATED
- FP-020 LADDER, PLATFORM ACCESS FP-028 BIKE RACK EXTERIOR
- FP-029 GUARD RAIL
 - FP-037 SCUPPER AND DOWNSPOUT FP-042 SOLID WALL PATTERN DENOTES WALL CONTINUOUS TO STRUCTURE ABOVE AND INSULATED

430' - 0"

27' - 0"

- LOCATE ANY UTILITIES WITHIN THIS REGION A MINIMUM OF 4'-0" BELOW FINISH FLOOR TO ALLOW FOR FUTURE DOCK LEVELERS

2 - 3"9' - 0" 4' - 6" 9' - 0"2' - 3" TYP.

54' - 0"


27' - 0"


- FP-043 STEEL STAIR WITH STEEL GRATE TREADS FP-044 VAPOR RETARDER AT PROPOSED OFFICE
- FP-045 PERIMETER SLAB INSULATION WHERE INDICATED ON PLANS
- FP-053 WATER LINE ABOVE AND SANITARY SEWER LINE BELOW SLAB


54' - 0"

27' - 0"

4' - 6" 9' - 0" 9' - 0" 4' - 6"

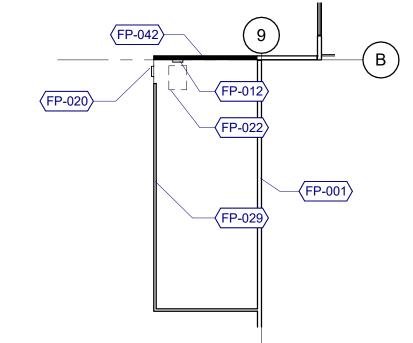

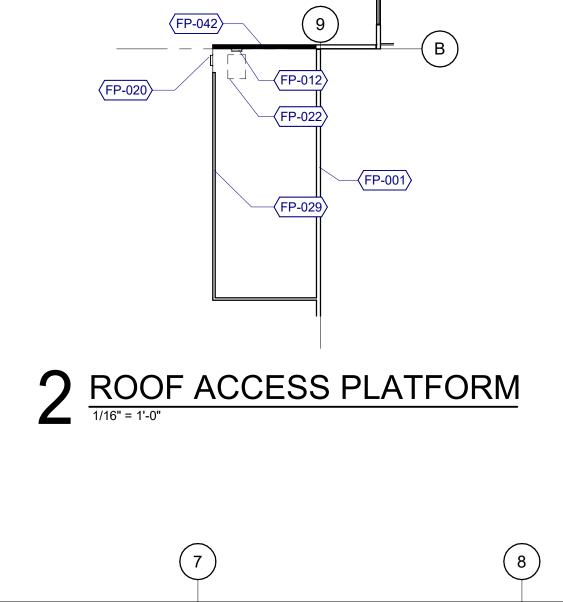

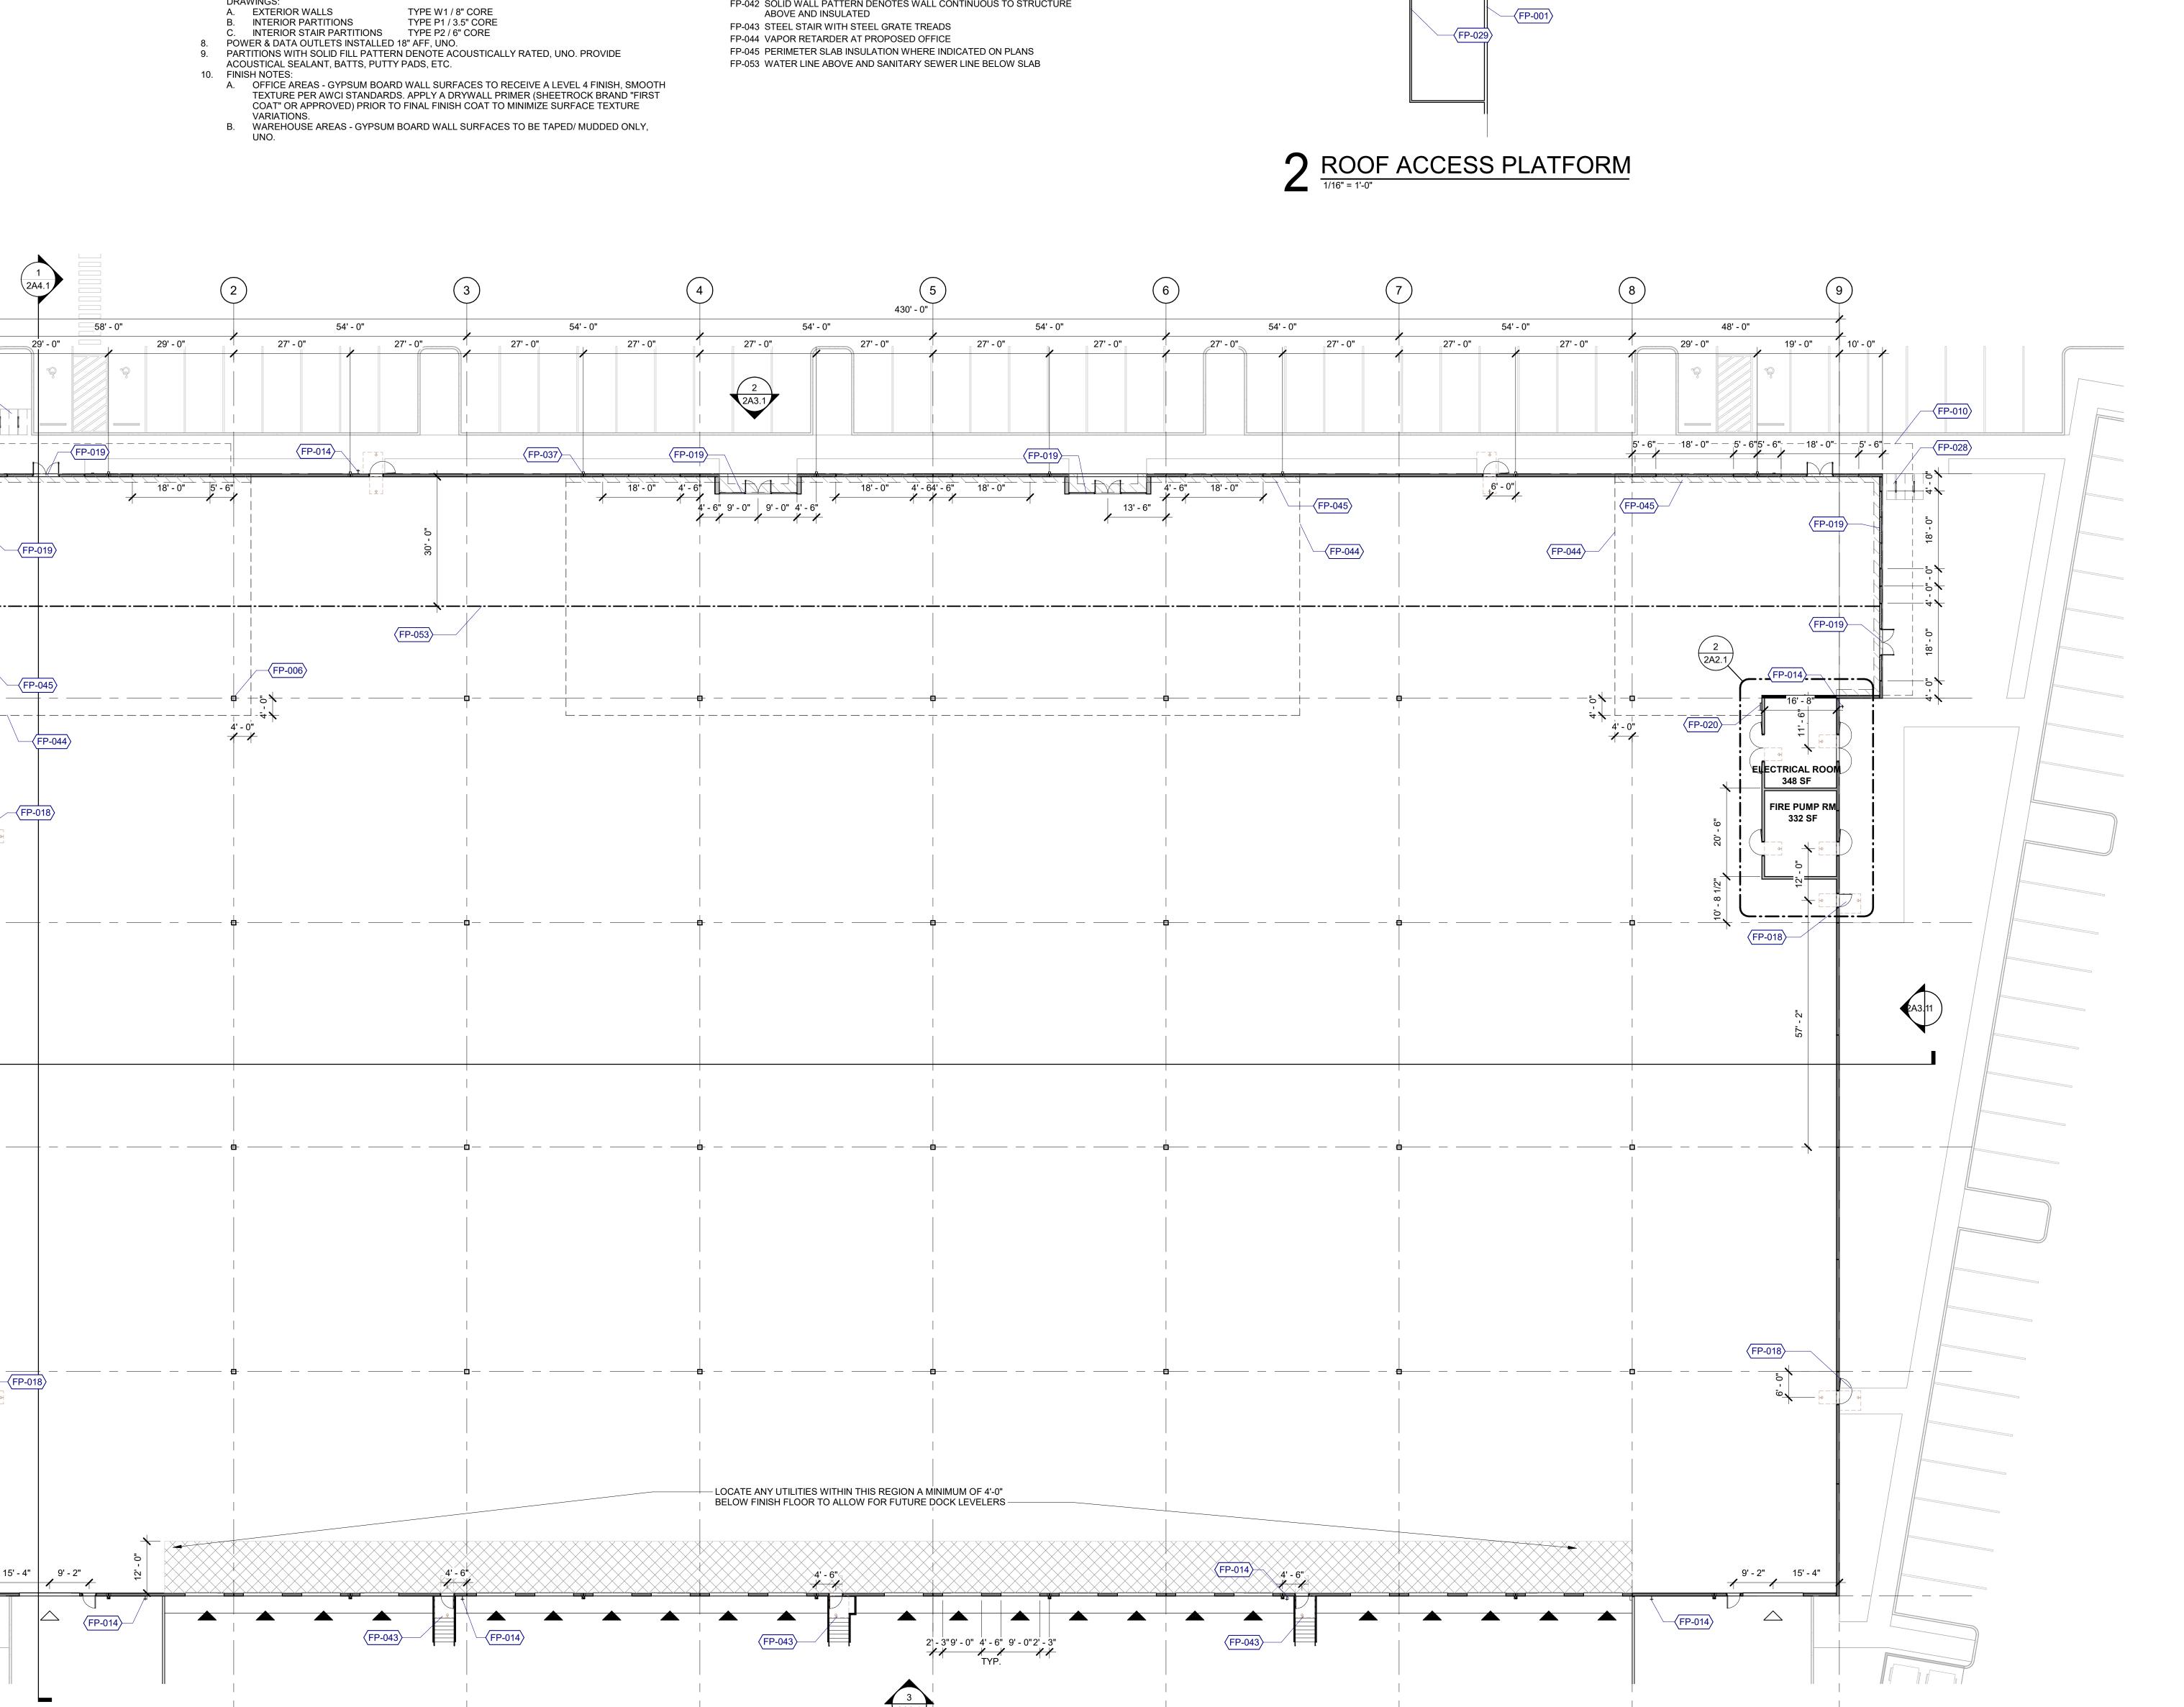

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4875 SW GRIFFITH DRIVE, SUITE 300

BEAVERTON, OREGON 97005

0 | 503.244.0552

Client/ Owner: GORDON

CENTERS

CLIENT ADDR

TRUCK

BUILDING **ADDITION**

5801 NE OLD SALEM ROAD

Sheet Title:

MILLERSBURG, OR

FLOOR PLAN, OVERALL BLDG

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LEGEND SKYLIGHT SMOKE AND HEAT VENT **ROOF HATCH** SMOKE AND HEAT VENT AREA <u>CALCULATION</u> PER 910.3.3 FOR SPRINKLER STORAGE AREA VENT AREA = VOLUME OF AREA /9000

<u>WAREHOUSE</u> VENT AREA REQUIRED (3,873,025/ 9000))= 430.4 SF (REQUIRED)

TOTAL # VENTS REQUIRED= 430.4/32 = 13.45 VENTS (REQUIRED) (14 PROVIDED)

VENT SIZES= 4'X8'= 32 SF

SKYLIGHT AREA CALCULATIONS

SKYLIGHT SIZE/ QUANTITY: DAYLIGHT AREA UNDER SKYLIGHT .7 x 30 FT CEILING HEIGHT = 21' = 42' EACH WAY (EW) (4'W + 42' EW = 46'W) x (8'L + 42' EW = 50'L) = 2,300 SF BUILDING AREA / DAYLIGHT AREA 111,388 SF*50% = 55,694 / 2,300 SF = 25 SKYLIGHTS, MIN (28) PROVIDED > 25, OKAY

DOWNSPOUT CALCULATIONS

PRELIMINARY CALCULATIONS - PLUMBING CONTRACTOR TO VERIFY PER OPSC TABLE 1103.1

ESTIMATED RAIN FALL PER TABLE D 101.1 = 1.3 IN/HOUR TOAL ROOF AREA = 111,388 SF 111,388 / 27,000 SF = (4.13) 6" DOWNSPOUTS REQUIRED (16) PROVIDED > 5, OKAY

GENERAL NOTES - ROOF PLANS

- REFER TO SHEET G0.1 FOR 'PROJECT NOTES' APPLICABLE TO ALL PORTIONS OF THE WORK.
 PROVIDE ROOFING MANUFACTURER'S STANDARD WALKWAY PADS BETWEEN ALL ROOF HATCHES, ROOF ACCESS DOORS, AND ROOFTOP EQUIPMENT AND AROUND PERIMETER OF ALL ROOFTOP
- PROVIDE POSITIVE ROOF SLOPE TO DRAIN AT MINIMUM SLOPE OF 1/4" PER FOOT, UNO.
 ROOF PENETRATIONS SHOWN ARE SCHEMATIC IN NATURE; COORDINATE ACTUAL SIZE, TYPE AND LOCATION OF EQUIPMENT. CURBS, AND ANY OTHER ROOF PENETRATIONS THAT MAY BE REQUIRED

FOR FLASHINGS, COPINGS, SCUPPERS AND OTHER SHEET METAL CONSTRUCTION.

- TO SUPPORT, SECURE OR FLASH ROOFTOP EQUIPMENT. COMPLY WITH THE MOST STRINGENT OF SMACNA, NRCA OR MANUFACTURERS' REQUIREMENTS
- 6. VERIFY ROOFING MANUFACTURER'S MINIMUM REQUIREMENTS FOR LAPPING OF ALL MATERIALS. BRING CONFLICTS WITH ARCHITECTURAL DETAILS TO THE ATTENTION OF THE ARCHITECT PRIOR
- SKYLIGHT/ SMOKE AND HEAT VENT CURBS R-5 MIN, UNLESS INCLUDED AS A COMPONENT OF SKYLIGHT LISTED AND LABELED IN ACCORDANCE WITH NFRC 100.
- MECHANICAL CURBS R-13, MIN. LOCATE ROOFTOP MECHANICAL EQUIPMENT 10'-0" MIN FROM INSIDE F.O. PARAPET/ ROOF EDGE SO GUARDRAIL NOT REQUIRED.

KEYNOTES

SCUPPER AND DOWNSPOUT RP-001 STEEL CANOPY BELOW

RP-005 RIDGE

RP-006 VALLEY RP-007

CRICKET

RP-009 ROOF ACCESS HATCH, CRICKET ON HIGH SIDE SMOKE AND HEAT VENT, CRICKET ON HIGH SIDE

SKYLIGHT, CRICKET ON HIGH SIDE

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GORDON

CENTERS

BUILDING

ADDITION

5801 NE OLD SALEM ROAD MILLERSBURG, OR


ROOF PLAN

Sheet Title:

BLDG B

TRUCK

CLIENT ADDR

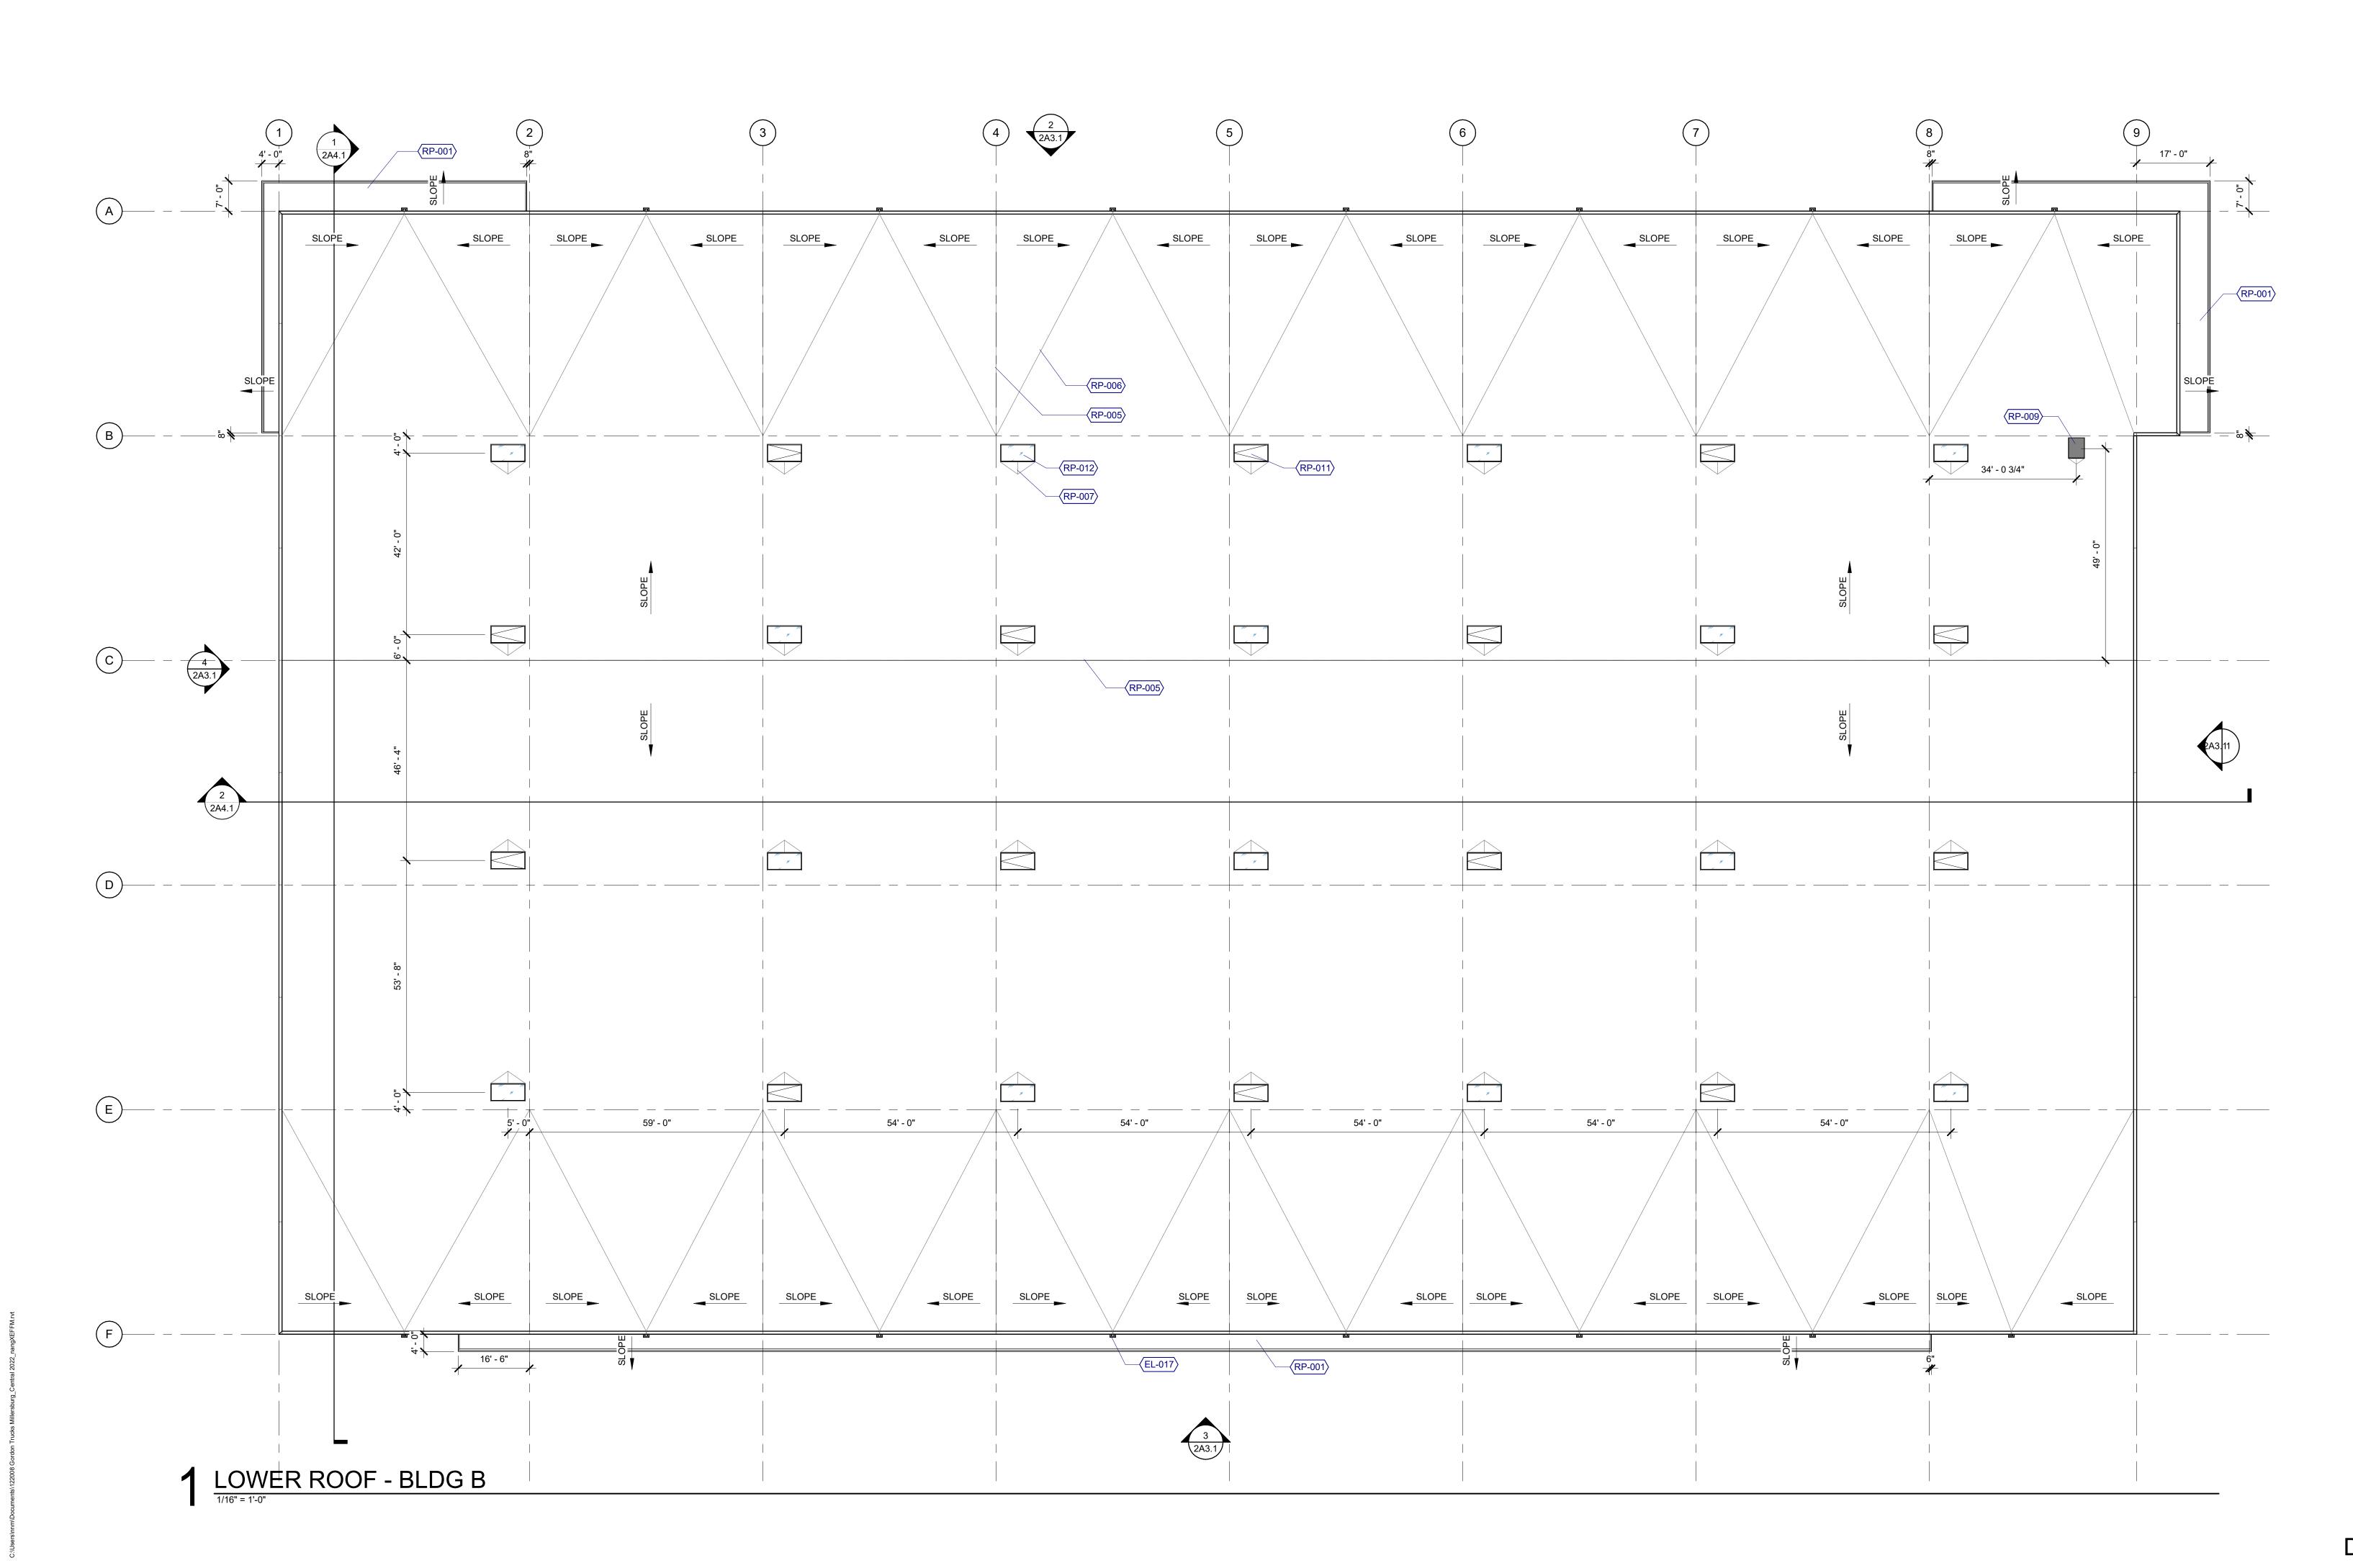

Sheet

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6/20/2023

121143



CONSTRUCTION

GORDON

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BUILDING

ADDITION

5801 NE OLD SALEM ROAD

MILLERSBURG, OR


ELEVATIONS

Sheet Title:

BLDG B

TRUCK

CLIENT ADDR

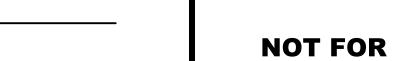

GENERAL NOTES - EXTERIOR ELEVATIONS

REFER TO SHEET G0.1 FOR 'PROJECT NOTES' APPLICABLE TO ALL PORTIONS OF THE WORK.
 ELEVATIONS NOTED ARE RELATIVE TO PROJECT DATUM.
 REFER TO SHEET G0.4 FOR VERTICAL AND HORIZONTAL ASSEMBLY TYPES.
 CONTRACTOR TO VERIFY SAFETY GLAZING REQUIREMENTS & LOCATIONS.
 EXTERIOR GLAZING TYPE GL-X, UNO.
 BUILDING ADDRESS SIGNAGE...(ZONING).

MATERIALS SCHEDULE (REFER TO 2A3.2)

KEYNOTES

UPPER ROOF - BLDG B LOWER ROOF - BLDG B 40' - 0" CLEAR HEIGHT - BLDG B LEVEL 1 - BLDG B 4 BLDG B - SOUTH ELEVATION UPPER ROOF - BLDG B


LOWER ROOF - BLDG B 40' - 0" CLEAR HEIGHT - BLDG B

BLDG B - NORTH ELEVATION



2 BLDG B - WEST ELEVATION

1/16" = 1'-0"

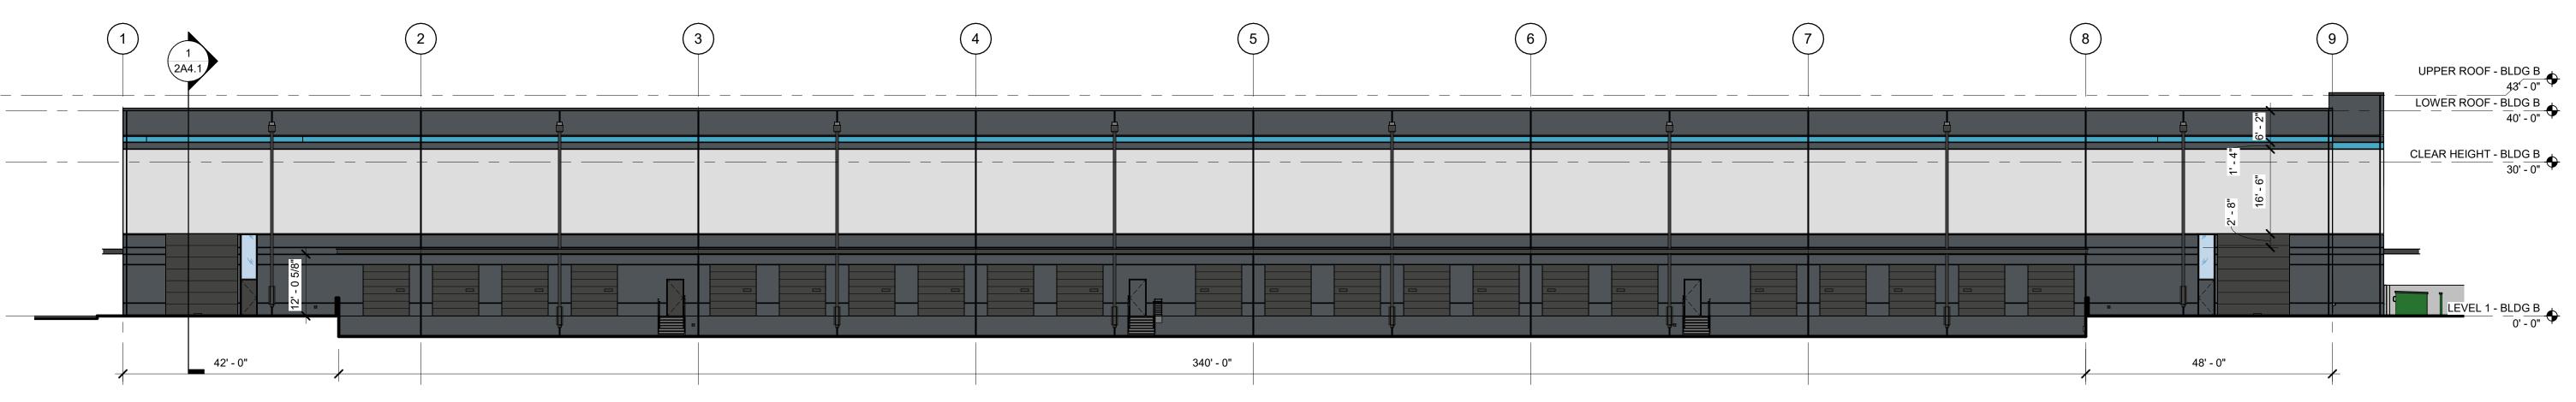

3 BLDG B - EAST ELEVATION

1/16" = 1'-0"

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Sheet

DESIGN REVIEW - JUNE 2023 2A3.1

EXTERIOR LIGHTING

Lithonia Lighting Pole Mounted Site Fixture DSX0 LED: P1, P2, P3, SM1, SM2, Finish: TBD



Gotham Round Downlight 4" EV04: R-1



Bega LED Wall Luminaires SM-3, Finish: TBD





BUILDING ELEMENT

EXTERIOR WALLS STOREFRONT GLAZING DOORS DOORS DOORS CANOPY **ENTRY SOFFIT** PARAPET COPING & FLASHING

<u>MATERIAL</u>

CONCRETE, TILT UP ALUMINIUM GLASS ALUMINIUM **HOLLOW METAL** OVERHEAD STEEL TUBE AND / OR CHANNEL WOOD METAL

<u>FINISH</u>


PAINT, SEE LEGEND ANODIZED, DARK BRONZE CLEAR ANODIZED, DARK BRONZE PAINT, SW 9640 SEA MARINER PAINT, SW 9640 SEA MARINER PAINT, SW 7069 IRON ORE CLEAR PAINT, SW 7069 IRON ORE

TEXTURE/ SHEEN


SMOOTH/ SATIN SMOOTH SMOOTH SMOOTH SMOOTH/ SATIN SMOOTH/ SATIN SMOOTH/ SATIN SMOOTH/ SATIN SMOOTH/ SATIN

COLOR


<u>PT-1</u> (MAIN BODY COLOR, DOOR COLOR, DOWNSPOUT) SW 9640 SEA MARINER

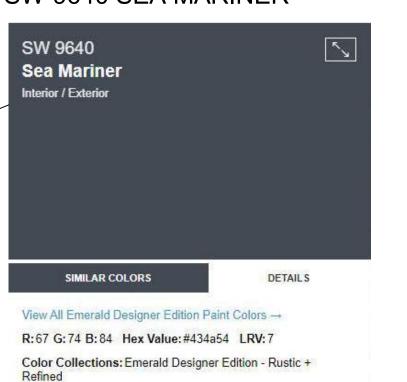

PT-2 (ACCENT BODY COLOR) SW 6246 NORTH STATR

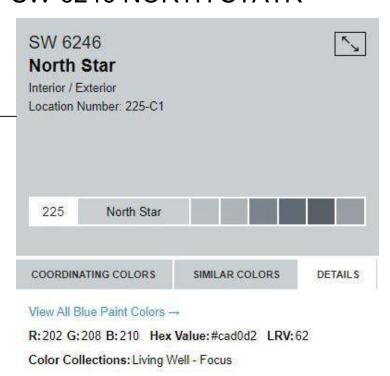

<u>PT-3</u> (TOP ACCENT COLOR) PATONE 7702 C

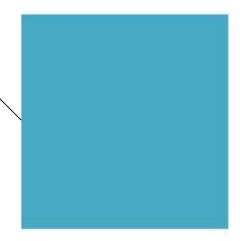

#48a9c5

RGB 72 169 197

<u>PT-4</u> (CANOPY, FLASHING) SW 7069 IRON ORE



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BUILDING **ADDITION**

5801 NE OLD SALEM ROAD MILLERSBURG, OR

Sheet Title:

EXTERIOR MATERIALS BLDG B

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GENERAL NOTES - WALL SECTIONS

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 REFER TO SHEET G0.4 FOR VERTICAL AND HORIZONTAL ASSEMBLY TYPES.

KEYNOTES

UPPER ROOF - BLDG B

LOWER ROOF - BLDG B 40' - 0"

CLEAR HEIGHT - BLDG B
30' - 0"

BLDG B_SECTION A

2 BLDG B SECTION B



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BUILDING ADDITION

5801 NE OLD SALEM ROAD MILLERSBURG, OR

Sheet Title:

OVERALL BUILDING SECTIONS BLDG B

Description

Description

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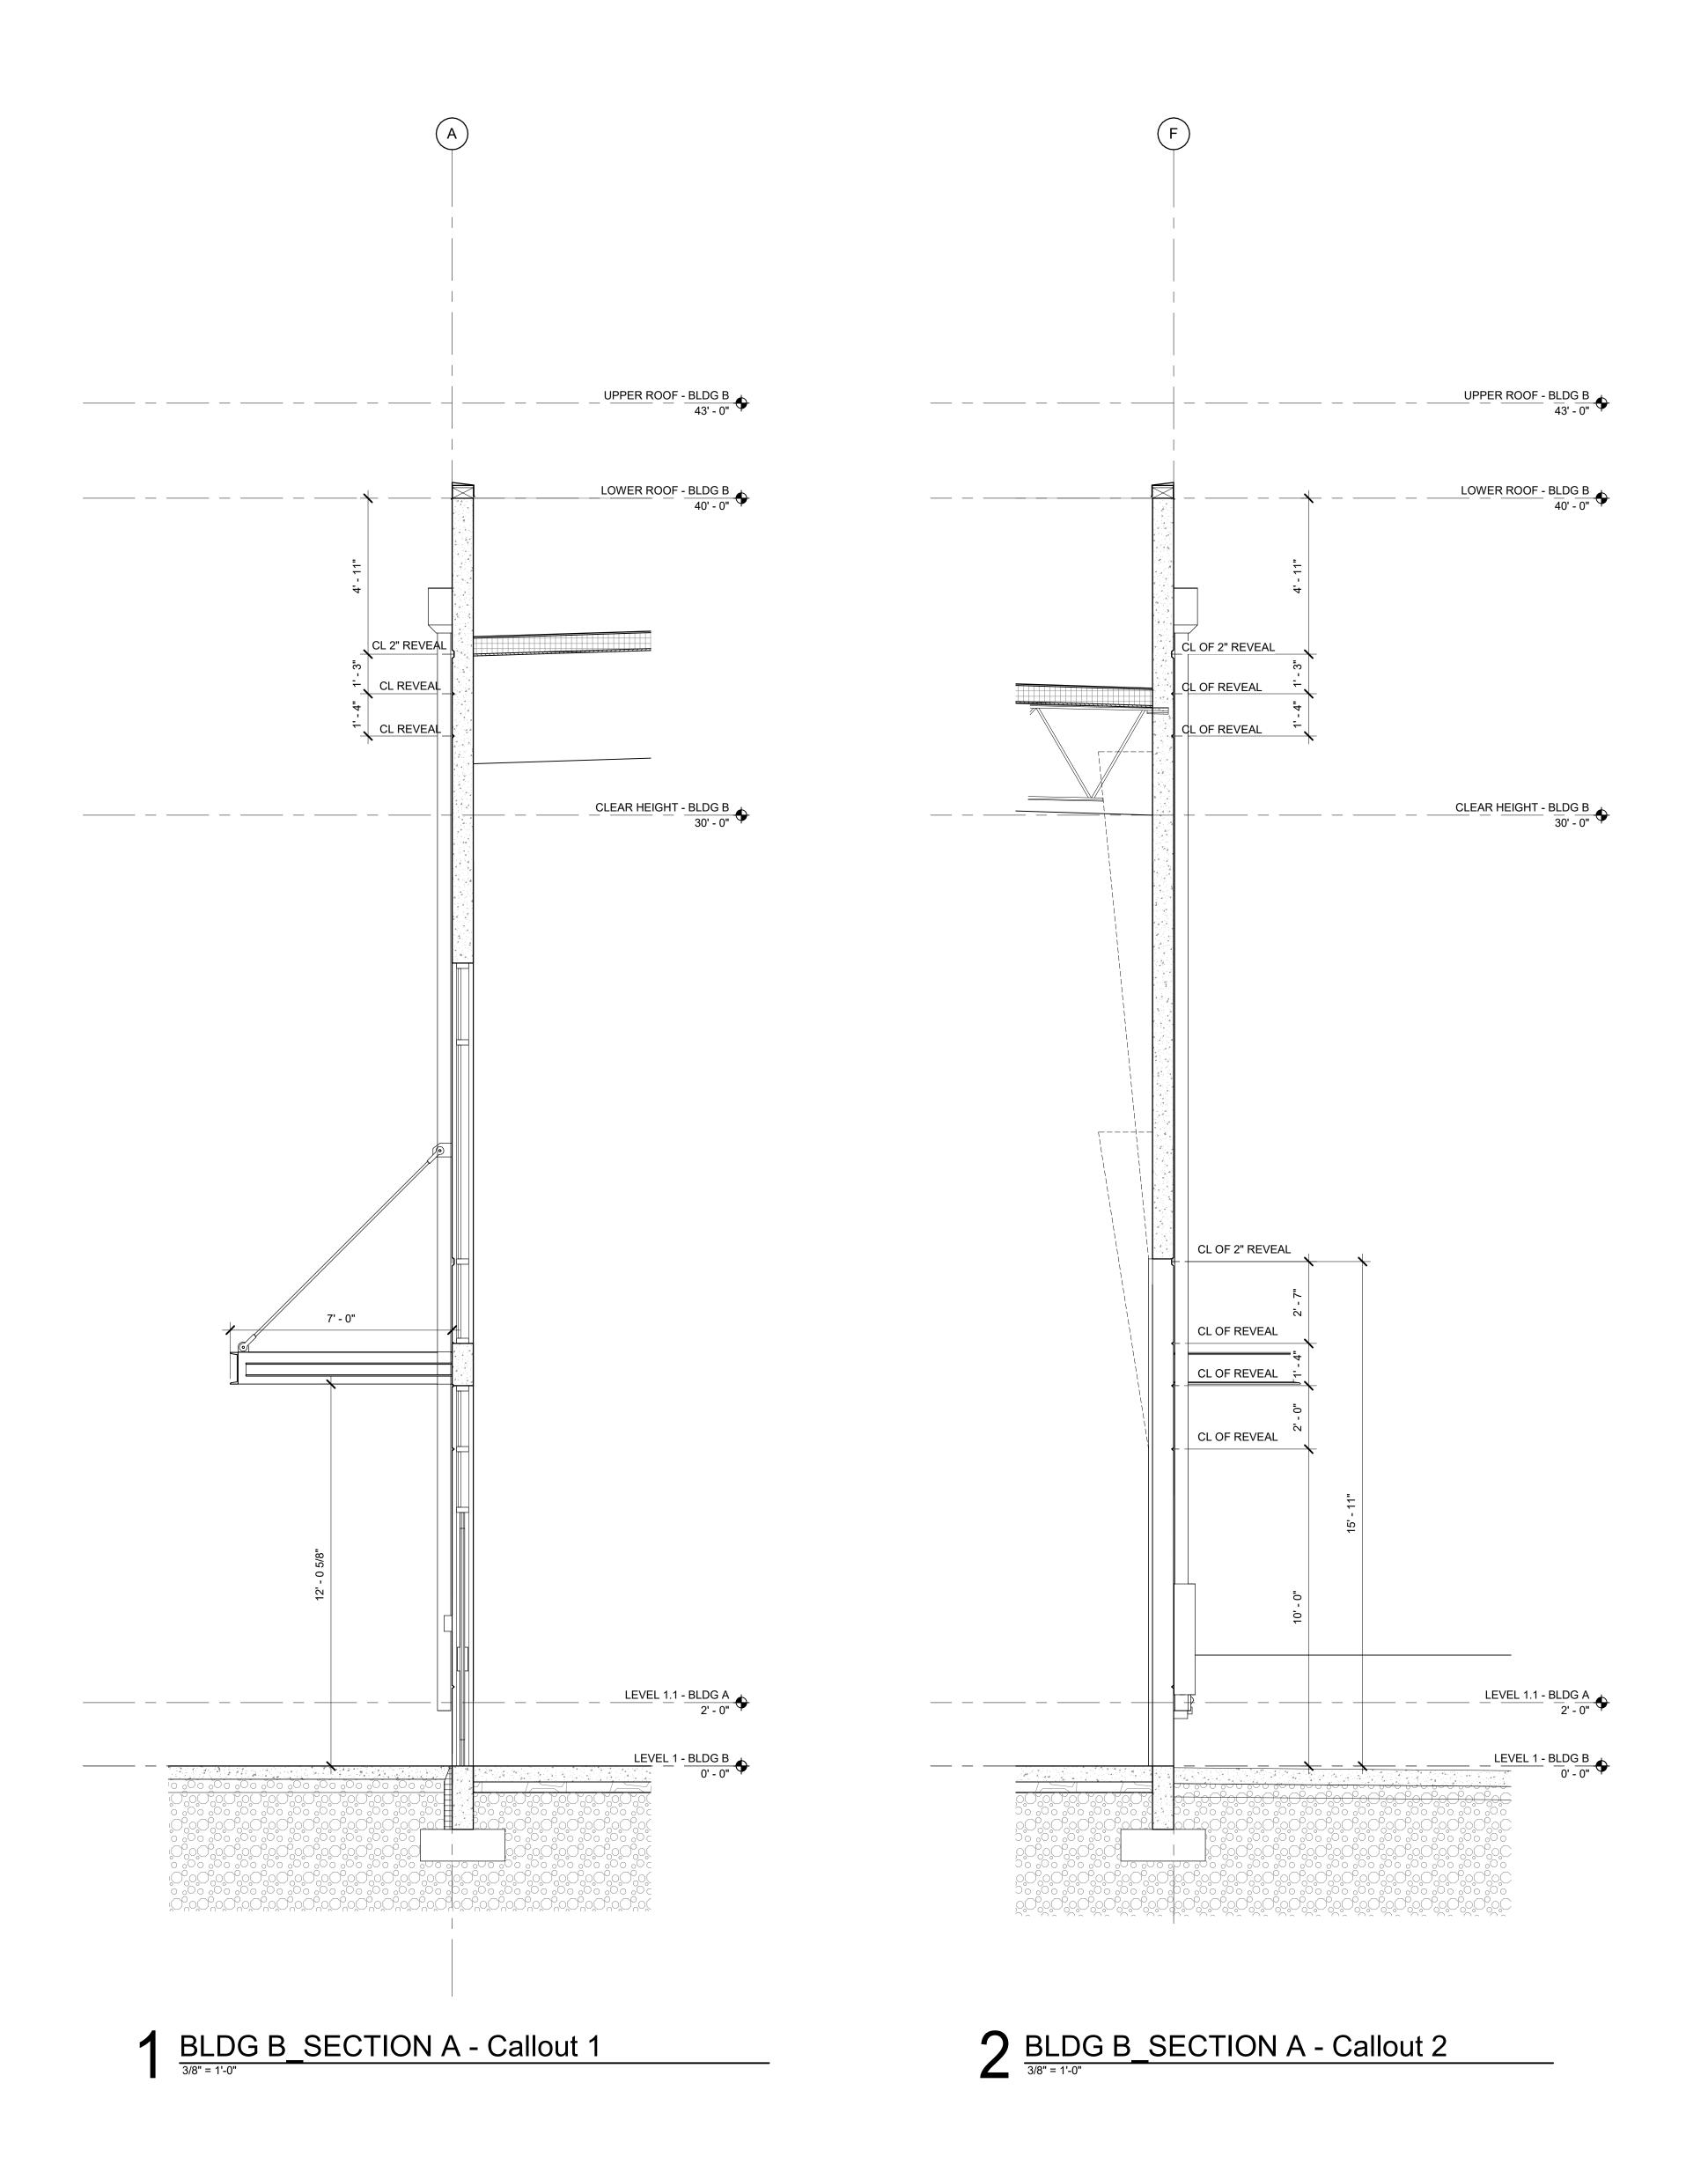
Job Number: 121143

Sheet

UPPER ROOF - BLDG B

LOWER ROOF - BLDG B 40' - 0"

CLEAR HEIGHT - BLDG B
30' - 0"



GENERAL NOTES - WALL SECTIONS

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KEYNOTES



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BUILDING ADDITION

5801 NE OLD SALEM ROAD MILLERSBURG, OR

Sheet Title:

WALL SECTIONS BLDG B

Revisions:

Description

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